Project Name: AS BUILTS

New Cold Storage Building:

ELAYN HUNT CORRECTIONAL CENTER Department of Corrections St. Gabriel, Louisiana

Project Number:

08-413-21-01, F.08000137

State ID: NEW Site Code: 2-24-004


Project Address: Elayn Hunt Correctional Center 6925 Highway 74 St. Gabriel, Louisiana 70776

Bidding and Contract Phase: June 15, 2022

State of Louisiana Govenor: JOHN BEL EDWARDS

Division on Administration: JAY DARDENNE

Office of Facility Planning and Control: **JASON D. SOOTER**

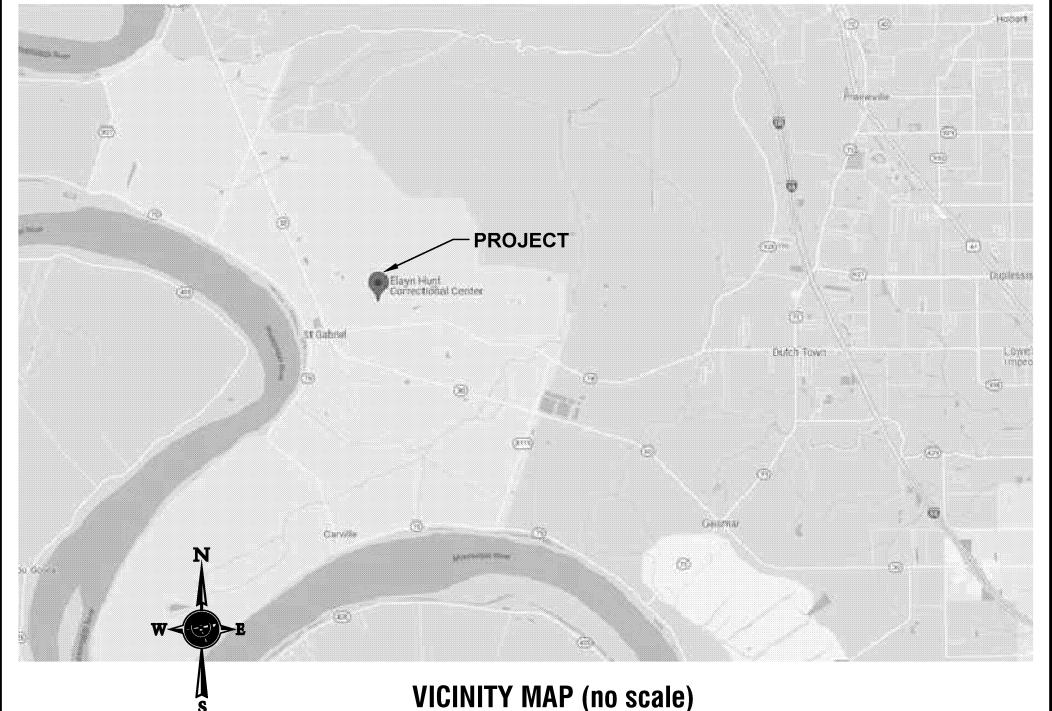

SHEET INDEX:

TITLE SHEET

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PAVING & GRADING PLAN

SITE DEMO PLAN

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FOUNDATION DETAILS

tor 18x24 prints.

TION

Sheet No._

PROJECT NOTES

3. CONTRACTOR SHALL VISIT THE SITE AND EXAMINE ALL EXISTING CONDITIONS PRIOR TO SUBMITTING BID/PROPOSAL. HE SHALL FAMILIARIZE

HIMSELF COMPLETELY WITH THE DIFFICULTIES AND RESTRICTIONS AFFECTING THE EXECUTION OF THE CONTRACT.

ANY), ALL WORK SHALL BE PERFORMED BY SKILLED AND QUALIFIED WORKMEN IN ACCORDANCE WITH THE BEST PRACTICES OF THE TRADES

4. ALL PRODUCTS, MATERIALS AND EQUIPMENT SHALL BE INSTALLED IN STRICT ACCORDANCE WITH THE MANUFACTURERS PRINTED INSTRUCTIONS AND SPECIFICATIONS. IN COMPLIANCE WITH ALL APPLICABLE CODES, AND WITHIN THE HIGHEST ACCEPTED COMMERCIAL TRADE STANDARDS BY SKILLED, EXPERIENCED, TRAINED AND COMPETENT CRAFTSMEN. USE ONLY NEW MATERIALS UNLESS OTHERWISE APPROVED BY ARCHITECT. MATERIALS SHALL BE USED ONLY FOR THE PURPOSE FOR WHICH THEY ARE DESIGNED/INTENDED.

5. ALL ASPECTS OF JOB SITE SAFETY ARE COMPLETELY THE RESPONSIBILITY OF THE CONTRACTOR. THE ARCHITECT WILL NOT HAVE CONTROL OR CHARGE OF AND WILL NOT BE RESPONSIBLE FOR CONSTRUCTION MEANS, METHODS, TECHNIQUES, SEQUENCES OR PROCEDURES, OR FOR SAFETY PRECAUTIONS AND PROGRAMS IN CONNECTION WITH THE WORK. CONTRACTOR SHALL PROVIDE ALL NECESSARY TEMPORARY SHORING, BRACING, BARRICADES AND PROTECTIVE BARRIERS AS REQUIRED TO INSURE SAFE EXECUTION OF DEMOLITION AND CONSTRUCTION.

6. WORK AREA SHALL BE KEPT NEAT, CLEAN, AND SAFE AT ALL TIMES BY CONTRACTOR. TRASH OR DEBRIS SHALL NOT BE ALLOWED TO ACCUMULATE ON THE SITE. PREMISES SHALL BE KEPT CLEAN, ORDERLY AND SAFE AT ALL TIMES CONTRACTOR SHALL BE RESPONSIBLE FOR PROVIDING SUITABLE TRASH CONTAINERS AND TRASH REMOVAL FROM THE SITE. ALL WASTE SHALL BE PROPERLY AND LEGALLY DISPOSED OF.

7. ALL DIMENSIONS, ANGLES, ELEVATIONS, CONDITIONS, AND PHYSICAL CONFIGURATIONS RELATIVE TO EXISTING CONDITIONS SHALL BE VERIFIED IN FIELD BY THE CONTRACTOR PRIOR TO COMMENCING CONSTRUCTION. BEFORE ORDERING ANY MATERIAL OR DOING ANY WORK, THE CONTRACTOR SHALL VERIFY ALL MEASUREMENTS AT THE SITE AND SHALL BE RESPONSIBLE FOR THE CORRECTNESS OF SAME. NO ALLOWANCE SHALL BE MADE ON ACCOUNT OF DIFFERENCES FOUND BETWEEN ACTUAL DIMENSIONS AND MEASUREMENTS AND THOSE INDICATED ON THE DRAWINGS. ANY DIFFERENCES FOUND BETWEEN ACTUAL AND DRAWINGS SHALL BE SUBMITTED TO THE ARCHITECT FOR CONSIDERATION BEFORE PROCEEDING WITH THE AFFECTED WORK. THE CONTRACTOR IS FULLY RESPONSIBLE FOR COORDINATION OF NEW WORK WITH EXISTING AND TO REPAIR ANY PART OF THE EXISTING BUILDING/PROPERTIES DAMAGED DUE TO THE NEW WORK/RENOVATION WITH MATERIALS TO MATCH EXISTING.

8. DO NOT SCALE ANY DRAWINGS WITHOUT SPECIFIC PERMISSION OF THE ARCHITECT. WRITTEN DIMENSIONS SHALL GOVERN CONSULT ARCHITECT FOR DIMENSIONS NOT SHOWN.

9. THE CONTRACTOR SHALL CAREFULLY EXAMINE THE DRAWINGS AND NOTES AND SECURE FROM THE ARCHITECT ANY ADDITIONAL INFORMATION, IF NECESSARY, THAT MAY BE REQUIRED FOR A COMPLETE, CLEAR AND FULL UNDERSTANDING OF THE WORK TO ESTABLISH THE COMPLETE SCOPE OF WORK AND TO ACHIEVE CLOSE COORDINATION BETWEEN ALL TRADES, EACH TRADE SHALL COMPLETELY REVIEW ALL DRAWINGS NOT ONLY THE DRAWINGS FOR HIS RESPECTIVE TRADE, BUT ALSO FOR THE WORK OF ALL OTHER TRADES AS WELL. NO TRADE SHALL PROCEED WITH ORDERING OR INSTALLATION OF ANY MATERIALS AND/OR EQUIPMENT WITHOUT FIRST COORDINATING WITH ALL OTHER TRADES. CONTRACTOR SHALL COORDINATE SUBCONTRACTOR'S WORK REQUIREMENTS TO INSURE THAT WORK CAN PROCEED CONTINUOUSLY AND EXPEDITIOUSLY AND WILL PROVIDE THE BEST RESULTS FOR THE COMPLETED WORK. TITLES AND NAMES ON DRAWINGS ARE PROVIDED MERELY FOR CONVENIENCE AND SHALL NOT BE CONSTRUED AS A SEGREGATION OF THE UNITS OF MATERIALS AND/OR LABOR INTO TRADES.

10. ALL PERMITS, LICENSES, APPROVALS, REVIEWS, AND INSPECTIONS NECESSARY FOR THE PROPER AND LEGAL EXECUTION AND COMPLETION OF THE WORK SHALL BE SECURED BY AND PAID FOR BY THE CONTRACTOR. CONTRACTOR SHALL GIVE ALL NOTICES TO ALL AUTHORITIES AND AGENCIES HAVING JURISDICTION OVER THE WORK. CONTRACTOR SHALL MAKE CERTAIN THAT ALL REQUIRED PERMITS AND APPROVALS HAVE BEEN OBTAINED PRIOR TO THE START OF ANY WORK. NO CONSTRUCTION OR FABRICATION SHALL BEGIN UNTIL THE CONTRACTOR HAS RECEIVED AND THOROUGHLY REVIEWED ALL DRAWINGS AND OTHER DOCUMENTS AS APPROVED BY ALL PERMITTING AUTHORITIES.

11. THE DRAWINGS ARE INTENDED TO DEFINE THE GENERAL DESIGN AND SCOPE OF THE WORK REQUIRED TO COMPLETE THE PROJECT, IT IS THE INTENT OF THESE DOCUMENTS TO PROVIDE FOR COMPLETE AND FINISHED WORK AND COMPLETE AND OPERATING SYSTEMS. ANY OMISSIONS IN THESE NOTES OR IN THE DRAWINGS SHALL NOT BE CONSTRUED AS RELIEVING THE CONTRACTOR OF SUCH RESPONSIBILITIES IMPLIED BY THE SCOPE OF WORK EXCEPT FOR ITEMS SPECIFICALLY NOTED. THE CONTRACTOR SHALL CAREFULLY EXAMINE THE BIDDING/CONTRACT DOCUMENTS AND SECURE FROM THE ARCHITECT ADDITIONAL INFORMATION, IF NECESSARY, THAT MAY BE REQUISITE TO A CLEAR AND FULL UNDERSTANDING OF THE WORK. ALL MISCELLANEOUS COMPONENTS, PARTS, ANCHORS, ACCESSORIES, MEANS OF INSTALLATION, DEMOLITION AND OTHER INCIDENTAL ITEMS REQUIRED FOR COMPLETE ASSEMBLY/INSTALLATION OF AN ITEM OR SYSTEM SHALL BE PROVIDED, WHETHER OR NOT SPECIFICALLY NOTED OR SPECIFIED. THE CONTRACTOR SHALL INCLUDE ALL COMPONENTS WHICH ARE NORMALLY INCIDENTAL TO THE WORK. THOSE COMPONENTS WHICH ARE REQUIRED AS AN ESSENTIAL AESTHETIC, FUNCTIONAL, OR CODE REQUIRED ELEMENT OF THE WORK ARE TO BE INCLUDED. ANY WORK OR MATERIAL THAT IS NOT DIRECTLY OR INDIRECTLY NOTED ON THE DRAWINGS BUT IS NECESSARY FOR THE PROPER CARRYING OUT OF THE OBVIOUS INTENTION IS TO BE UNDERSTOOD AS "IMPLIED" AND IS TO BE PROVIDED BY THE CONTRACTOR AS FULLY AS IF SPECIFICALLY DESCRIBED OR DELINEATED HEREIN ANY DISCREPANCIES IN THE DRAWINGS SHALL BE REPORTED TO THE ARCHITECT FOR INTERPRETATION OR CORRECTION BEFORE WORK IS EXECUTED.

BEARING WALLS, COLUMNS, BEAMS, OR OTHER STRUCTURAL SUPPORT OF THE EXISTING BUILDING IS BEING REMOVED OR MANIPULATED, CONTRACTORS SHALL DO ALL NECESSARY SHORING, NEEDLING, UNDERPINNING, BRACING, ETC. AS REQUIRED TO MAINTAIN SAFETY OF THE STRUCTURE, WORKERS, AND THE GENERAL PUBLIC UNDER DIRECTION OF HIS OWN PROFESSIONAL ENGINEER. NO STRUCTURAL MEMBER SHALL BE CUT OR MANIPULATED IN ANY WAY WITHOUT PRIOR APPROVAL.

14. SIGNAGE IS NOT A PART OF THIS PROJECT.

15. ALL WORK WILL BE SUBJECT TO THE REVIEW, INSPECTION, AND ACCEPTANCE OF THE OWNER (AND THE ARCHITECT AT THE DISCRETION OF THE OWNER) UPON COMPLETION OF THE WORK. THE CONTRACTOR SHALL NOTIFY THE OWNER TO PREPARE A "PUNCHLIST" OF NEEDED CORRECTIONS AND UNSATISFACTORY AND/OR INCOMPLETE WORK. ALL PROGRESS PAYMENTS WILL HAVE A RETAINAGE WITHHELD AS OUTLINED IN THE SUPPLEMENTARY CONDITIONS SECTION 9.2.1.1 IN THE PROJECT MANUAL. PROGRESS PAYMENTS WILL BE MADE MONTHLY. NO DOWN PAYMENTS OR PREPAYMENTS OF ANY KIND WILL BE MADE. CONTRACTOR SHALL SUBMIT ITEMIZED AND DETAILED MONTHLY REQUESTS FOR PAYMENT, WHICH ARE SUBJECT TO APPROVAL BY THE OWNER AND ARCHITECT. CONTRACTOR SHALL SUBMIT A DETAILED ITEMIZED SCHEDULE OF VALUES WITH THE PROPOSAL. PAY REQUESTS SHALL BE BASED ON ACTUAL AMOUNT OF WORK COMPLETED (PERCENTAGE OF THE TOTAL FOR EACH LINE ITEM IN THE SCHEDULE OF VALUES). RETAINAGE WILL BE PAID UPON FINAL ACCEPTANCE OF ALL WORK AND UPON CONTRACTOR PROVIDING THE OWNER WITH CLEAR LIEN AND PRIVILEGE CERTIFICATE FROM THE CLERK OF COURTS.

16. CONTRACTOR SHALL PAY ALL APPLICABLE SALES TAXES AND ALL OTHER APPLICABLE TAXES AS PART OF THE BASE BID.

17. PROJECT INCLUDES ALL REQUIRED PREPARATION AND SELECTIVE DEMOLITION. PROTECT ALL SURROUNDING AREAS DURING CONSTRUCTION, PROTECT ALL EXISTING CONSTRUCTION TO REMAIN DURING ENTIRE CONSTRUCTION PERIOD, PROTECT THE STORE EMPLOYEES AND PATRONS DURING DEMOLITION AND CONSTRUCTION. CONTRACTOR MUST CONTAIN HIS WORK AND THE AFFECTS OF HIS WORK TO A LIMITED WORK AREA. RESTORE ALL AREAS TO PRE-CONSTRUCTION CONDITIONS OR BETTER WITHOUT ADDITIONAL COMPENSATION. THIS INCLUDES GRADING ANY DISTURBED GRADES AND RESTORATION OF THE TURF AND LANDSCAPING. CONTRACTOR SHALL REVIEW WITH THE OWNER IN THE FIELD ALL EXISTING DAMAGE TO EXISTING CONSTRUCTION AND SITE. A DETAILED LIST SHALL BE PREPARED BY THE CONTRACTOR AND APPROVED BY THE OWNER PRIOR TO THE START OF WORK. ANY DAMAGE NOT ON THE APPROVED LIST SHALL BE THE RESPONSIBILITY OF THE CONTRACTOR TO CORRECT. IT IS SUGGESTED THAT THE LIST BE SUPPLEMENTED WITH PHOTOGRAPHS.

18. DURING THE BIDDING OR NEGOTIATION PERIOD, ANY DISCREPANCIES, CONFLICTS, AND/OR QUESTIONS OF INTERPRETATIONS IN THE DRAWINGS SHALL BE SUBMITTED TO THE ARCHITECT PROMPTLY FOR CLARIFICATION. THE ARCHITECT WILL ISSUE WRITTEN ADDENDA TO BIDDERS CLARIFYING SUCH MATTERS. THE ARCHITECT WILL NOT BE RESPONSIBLE FOR VERBAL INSTRUCTIONS. NO ALLOWANCE SHALL BE MADE AFTER THE BID OPENING FOR MISUNDERSTANDING ON THE PART OF THE CONTRACTOR. IT SHALL BE HELD THAT ALL BIDDERS AND THEIR SUBCONTRACTOR/MATERIAL SUPPLIERS HAVE EXAMINED ALL DRAWINGS/DOCUMENTS/ADDENDA AND THE SITE FOR PROPER COMPREHENSION OF

19. CONTRACTOR SHALL EMPLOY EXPERIENCED, FULLY QUALIFIED AND LICENSED SUB-CONTRACTORS AND MAINTAIN COOPERATION AMONG ALL TRADES.

20. THE CONTRACTOR SHALL SUB-CONTRACT WITH SUPPLIERS, FABRICATORS, AND INSTALLERS THAT CAN DEMONSTRATE THAT THEY POSSESS THE KNOWLEDGE, EXPERIENCE, EXPERTISE, PERSONNEL, AND PROVEN CAPABILITIES IN THE WORK SPECIFIED TO FULLY PERFORM ALL ASPECTS OF THE WORK (OR A SPECIFIC DESIGNATED PORTION OF THE WORK) REQUIRED WITHOUT OMISSION OR EXCEPTION.

21. PRECAUTIONS AND PROTECTIVE MEASURES SHALL BE USED AS REQUIRED TO PROTECT WORKERS, AND THE GENERAL PUBLIC. ERECT SUITABLE TEMPORARY BARRIERS AT HAZARDOUS AREAS TO DETOUR PEDESTRIAN TRAFFIC AND TO PREVENT NORMAL ACCESS TO SUCH AREAS BY UNAUTHORIZED PERSONS.

22. REFER TO SUPPLEMENTARY CONDITIONS ARTICLE 11.

23. REFER TO SPECIFICATION BOOK ON TESTING.

24. IN THE EVENT THE CLIENT, THE CLIENT'S CONTRACTOR OR SUBCONTRACTORS, OR ANYONE FOR WHOM THE CLIENT IS LEGALLY LIABLE MAKES OR PERMITS TO BE MADE ANY CHANGES TO ANY REPORTS, PLANS, SPECIFICATIONS OR OTHER CONSTRUCTION DOCUMENTS PREPARED BY THE ARCHITECT WITHOUT OBTAINING THE ARCHITECT'S PRIOR WRITTEN CONSENT, THE CLIENT SHALL ASSUME FULL RESPONSIBILITY FOR THE RESULTS OF SUCH CHANGES. THEREFORE THE CLIENT AGREES TO WAIVE ANY CLAIM AGAINST THE ARCHITECT AND TO RELEASE THE ARCHITECT FROM ANY LIABILITY ARISING DIRECTLY OR INDIRECTLY FROM SUCH CHANGES. ADDITIONALLY, THE CLIENT AGREES TO INCLUDE IN ANY CONTRACTS FOR CONSTRUCTION APPROPRIATE LANGUAGE THAT PROHIBITS THE CONTRACTOR OR ANY SUBCONTRACTORS OF ANY LEVEL FROM MAKING ANY CHANGES OR MODIFICATIONS TO THE ARCHITECT'S CONSTRUCTION DOCUMENTS WITHOUT THE PRIOR WRITTEN APPROVAL OF THE ARCHITECT AND THAT FURTHER REQUIRES THE CONTRACTOR TO INDEMNIFY BOTH THE ARCHITECT AND THE CLIENT FROM ANY LIABILITY OR COST ARISING FROM SUCH CHANGES MADE WITHOUT SUCH PROPER AUTHORIZATION.

25. THE CONTRACTOR SHALL BE RESPONSIBLE FOR COMPLIANCE WITH THE CLEAN AIR ACT, AS AMENDED (33 U.S.C. 1251 ET SEQ.), AND THE LOUISIANA ENVIRONMENTAL QUALITY ACT, AS AMENDED (LA. R.S.30:2001 ET SEQ.), RULES AND REGULATIONS EFFECTIVE OR PROMULGATED UNDER THE AUTHORITY OF SAID ACTS. CONTRACTOR SHALL BE RESPONSIBLE FOR OBTAINING, AND PURCHASING ALL REQUIRED PERMITS INCLUDING THE LOUISIANA POLLUTANT DISCHARGE ELIMINATION SYSTEM, (LPDES) GENERAL PERMIT. CONTRACTOR SHALL BE RESPONSIBLE FOR COMPLYING WITH ALL APPLICABLE REQUIREMENTS SET FORTH BY THE LPDES PERMIT AUTHORITIES, WHICH AUTHORIZES THE DISCHARGE OF STORM WATER FROM SMALL CONSTRUCTION ACTIVITIES WHICH DISTURBS AN AREA OF LAND GREATER THAN ONE ACRE, (GREATER THAN ONE ACRE BUT LESS THAN FIVE ACRES), TO WATERS OF THE STATE.

26. IN CASE OF DISCREPANCIES AND/OR AMBIGUITIES IN THE DRAWINGS AND/OR IN THE SPECIFICATIONS, CONSULT ARCHITECT PRIOR TO SUBMISSION OF A PROPOSAL/BID. FAILURE TO DO SO ON THE PART OF THE SUCCESSFUL BIDDER SHALL BE CONSTRUED AS EXPLICIT AGREEMENT ON HIS PART TO ABIDE BY THE ARCHITECT'S DECISION IN SUCH MATTERS.

27. ALL FACILITIES USED BY THE CONTRACTOR ARE TO BE RETURNED TO THE CONDITION IN WHICH THEY WERE FOUND AT THE START OF THE PROJECT. CONTRACTOR SHALL NOTE AND RECORD THE CURRENT CONDITION PRIOR TO THE START OF ANY WORK.

28. PORTABLE HAND HELD FIRE EXTINGUISHERS SHALL BE PROVIDED AS PER NFPA

29. ALL FIRE EXTINGUISHERS SHALL BE UL LISTED/LABELED AND FM APPROVED. A REGISTERED/CERTIFIED FIRE EXTINGUISHER FIRM SHALL PERFORM ALL FIRE EXTINGUISHER WORK.

30. INSTALL SMOKE DETECTORS TO AUTOMATICALLY STOP THE FAN IN HVAC DUCT SYSTEMS OVER 2000 CFM IN ACCORDANCE WITH NFPA 90A.


31. LOCKS ON DOORS IN MEANS OF EGRESS SHALL NOT REQUIRE THE USE OF A KEY, SPECIAL DEVICE OR SPECIAL KNOWLEDGE TO OPEN IN THE DIRECTION OF EGRESS. LOCKS ON EGRESS DOORS SHALL BE OPERABLE WITH ONLY ONE RELEASING OPERATION. A TWO STEP RELEASE, SUCH AS A KNOB AND/OR INDEPENDENT SLIDE BOLT, IS NOT ACCEPTABLE.

32. INSULATION AND INSULATION ASSEMBLIES SHALL MEET THE REQUIREMENTS OF IBC, LATEST EDITION. A. CONCEALED INSULATION SHALL HAVE A FLAME SPREAD OF 0-25 AND A SMOKE DEVELOPED OF 0-450 EXCEPT THAT IN COMBUSTIBLE (WOOD FRAME) CONSTRUCTION.

B. EXPOSED INSULATION SHALL HAVE A FLAME SPREAD OF 0-25 AND A SMOKE DEVELOPED OF 0-450. C. INTERIOR WALLS AND CEILING SHALL HAVE A FLAME SPREAD OF 0-75 AND A SMOKE DEVELOPMENT RATING OF 0-450.

E. FOAM PLASTIC INSULATION SHALL MEET REQUIREMENTS OF IBC 719

D. CELLULOSE FIBER THERMAL INSULATION SHALL MEET REQUIREMENTS OF IBC 719.

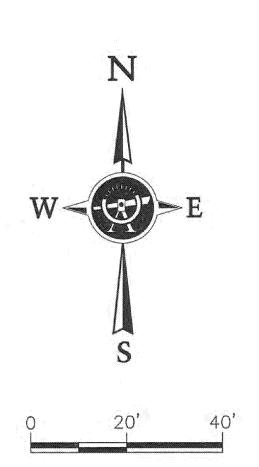



LEGEND

_LOLIND	
	Underground Drain Line
UG-T	Underground Telephone Line
	Guard Rail
X	Fence Line
	Pad Mounted Transformer
P	Electric Junction Box
Ø	Electric Manhole
O	Pipe Stub-Up
Ø	Water Faucet
0	Telephone Manhole
0	Septic Tank
0	Sewer Cleanout
0	Sign
	Bollard
[AC]	Air Conditioner Unit
¤	Area Light
N	Tree Stump
CLF	Chain Link Fence
GEN	Generator
CONC.	Concrete
- \$-	Temporary Bench Mark

Asphalt Pavement

Concrete Pavement

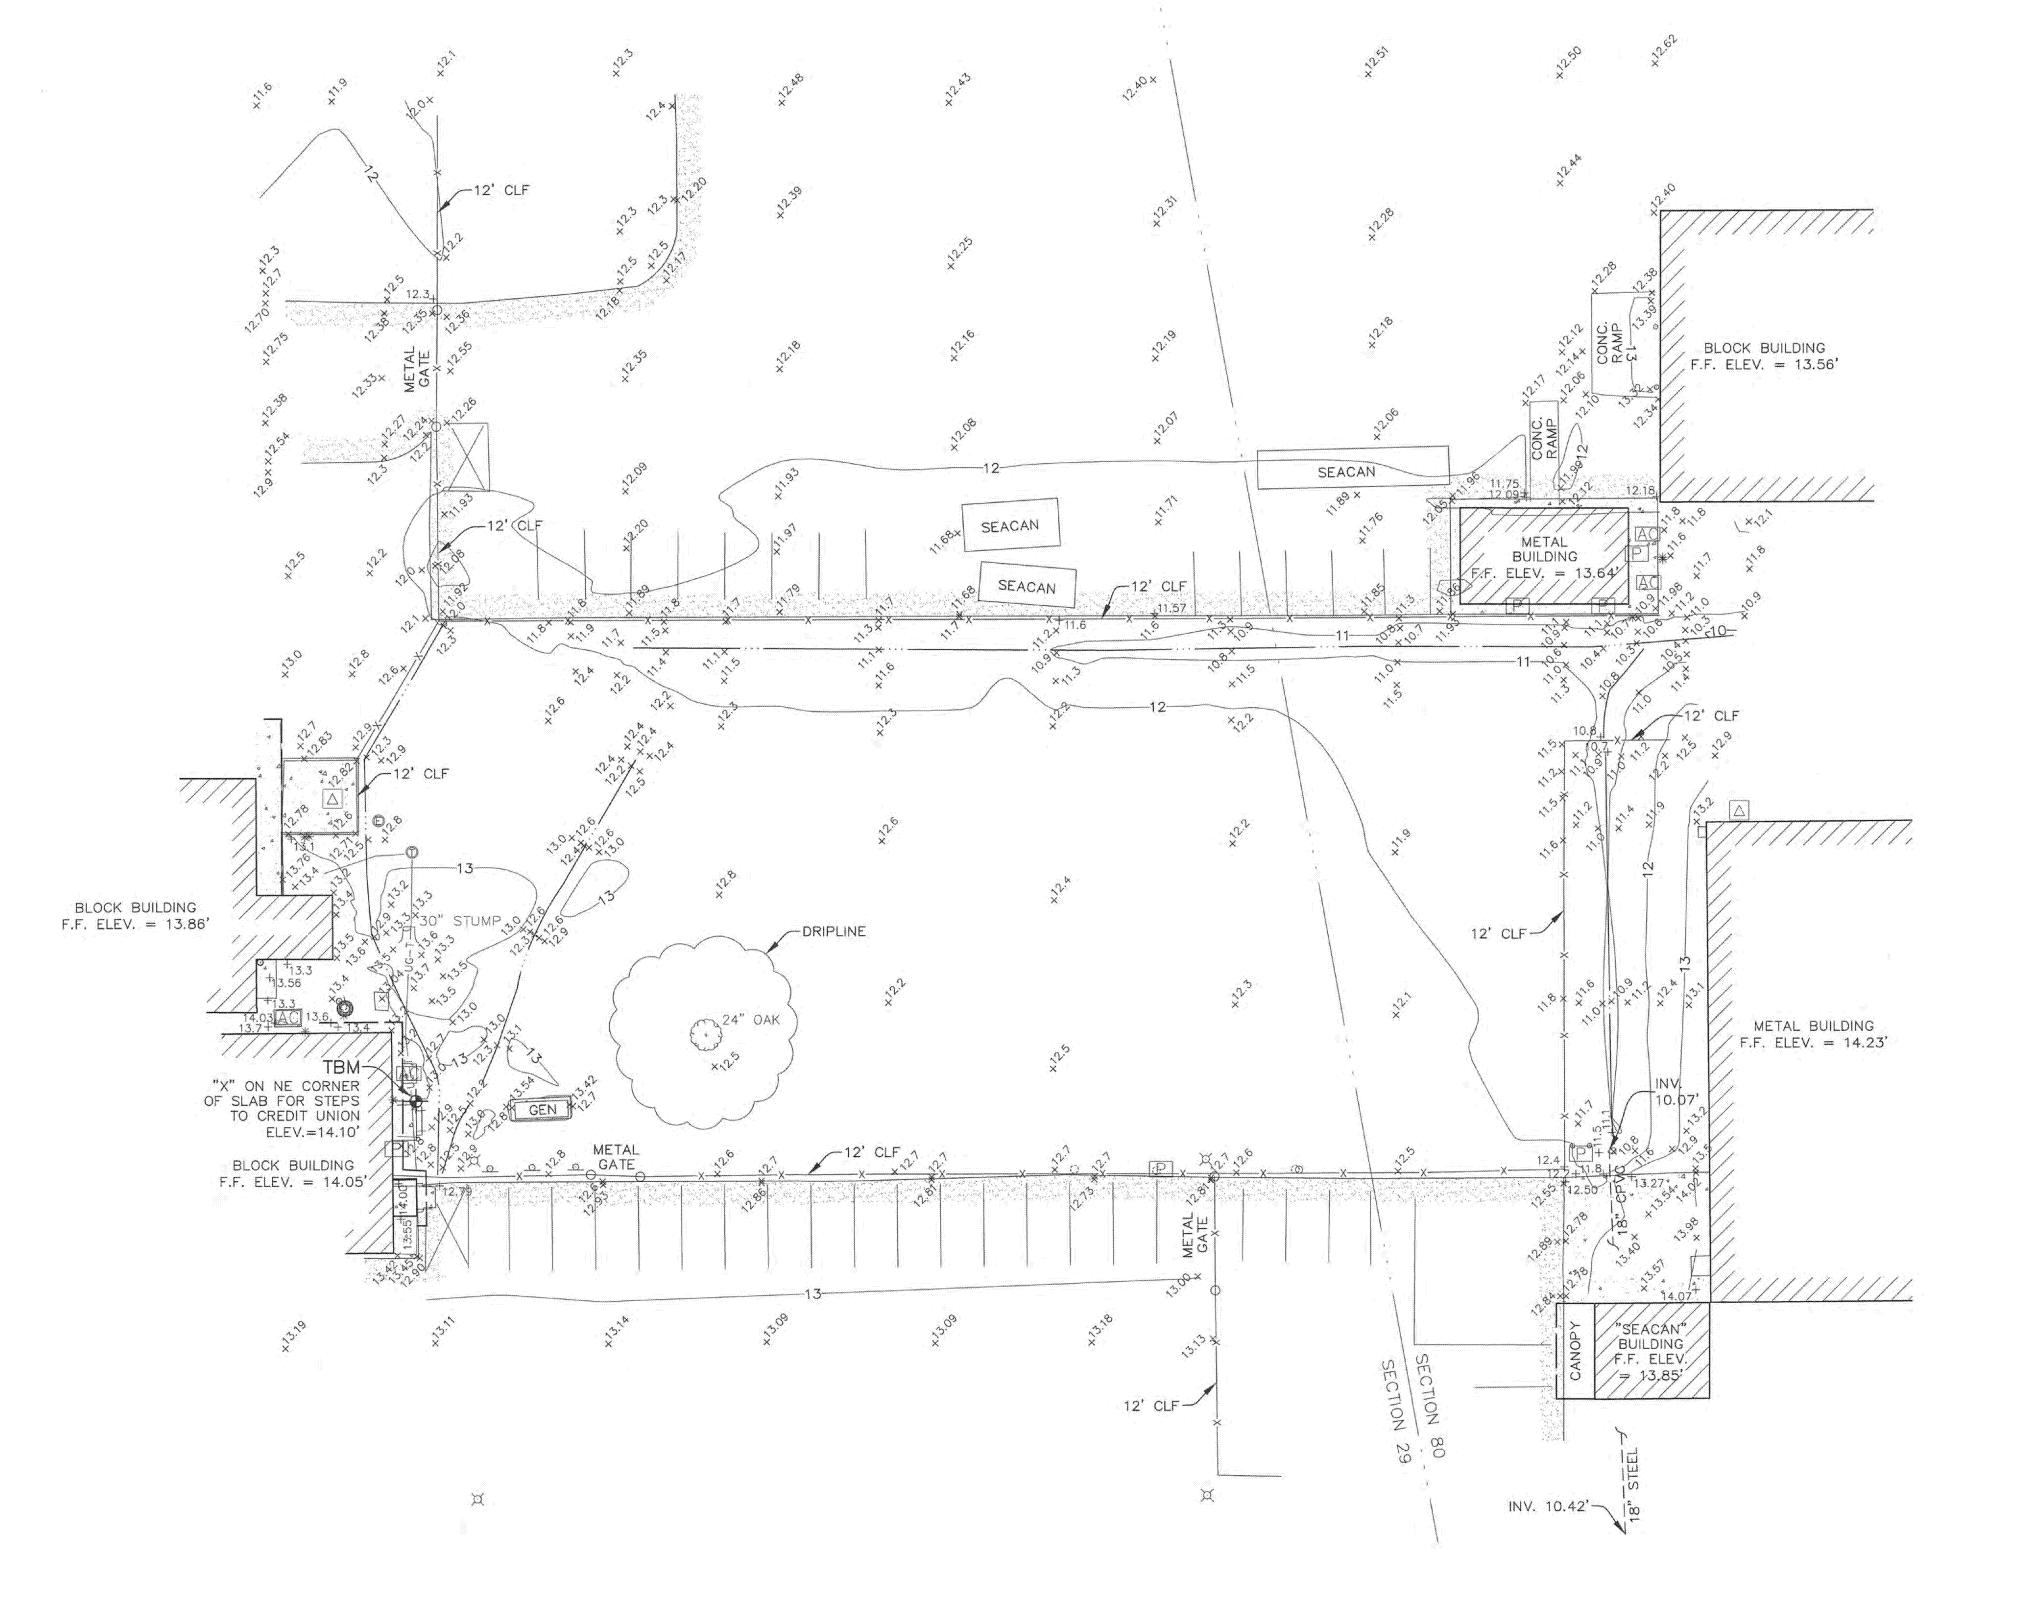

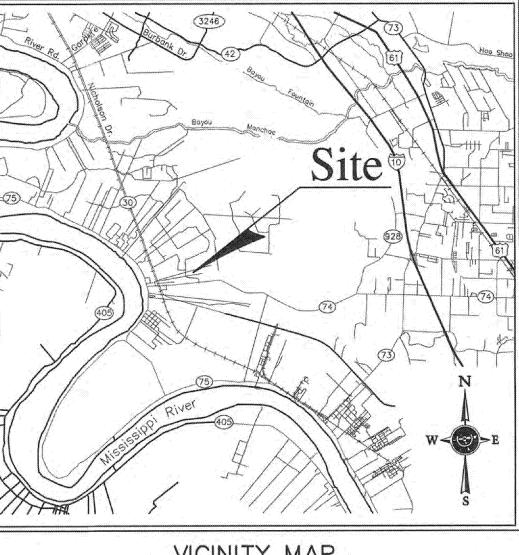

VICINITY MAP NOT TO SCALE

GENERAL NOTES:

1.) Flood Note: In accordance with FEMA Flood Insurance Rate Map Panel No. 22047C0240D for Iberville Parish Louisiana, last revised November 6, 2013, the property shown hereon is located in Flood Zone "X" (With Shading). Nearest adjacent Base Flood Elevation = 11 feet (NAVD 1988). The current base flood and inundation elevations are subject to change and should be verified with the Department of Development prior to issuance of building permits.

FLOOD AREAS DEFINED:

Zone "X" (With Shading): Areas of 0.2% annual chance flood; areas of 1% annual chance flood with average depths of less than 1 foot or with drainage areas less than 1 square mile; and areas protected by levees from 1% annual chance flood.

Flood Insurance Rate Maps are revised frequently and can be found online at: msc.fema.gov

- 2.) Zoning information should be verified with City/Parish Planning Commission.
- 3.) Elevations and TBM's were derived from the Leica Network System using Trimble R8 dual frequency GPS units. NAVD 1988 datum, Geoid 18.
- 4.) No attempt has been made by LandSource, Inc., to verify title, actual legal ownerships, deed restrictions, servitudes, easements, or other burdens on the property other than that furnished by the client or his representative.
- 5.) Utilities: The location of underground utilities was not in the scope of this survey.
- 6.) All spot elevations are not shown for clarity of the drawing.
- 7.) Section lines were digitized from the Iberville Parish Assessors site. They are shown for reference only and were not field verified at the time of this survey.


MAP SHOWING PARTIAL TOPOGRAPHIC SURVEY

OF A PORTION OF

ELAYN HUNT CORRECTIONAL CENTER

LOCATED IN SECTIONS 29 & 80, T-9-S, R-1-E, SOUTHEASTERN LAND DISTRICT EAST OF THE MISSISSIPPI RIVER, IBERVILLE PARISH, LOUISIANA

CRESS & LOPRESTO ARCHITECTS, LLC

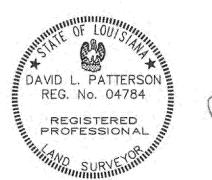

CERTIFICATION:

I hereby certify that I made a survey on the grounds of the property shown and that this drawing accurately reflects the findings of said survey.

David L. Patterson, P.L.S.

23 MARCH 2022

SHEET NO: A-0.0

MAR. 23, 2022

лов #: 21-583-01

DWN. BY: SLP


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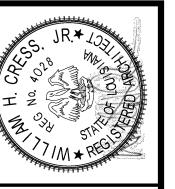
© ALL RIGHTS RESERVED P: \lsi\21\21-583\21-583-01.dwg

before

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La. Registration No. 04784



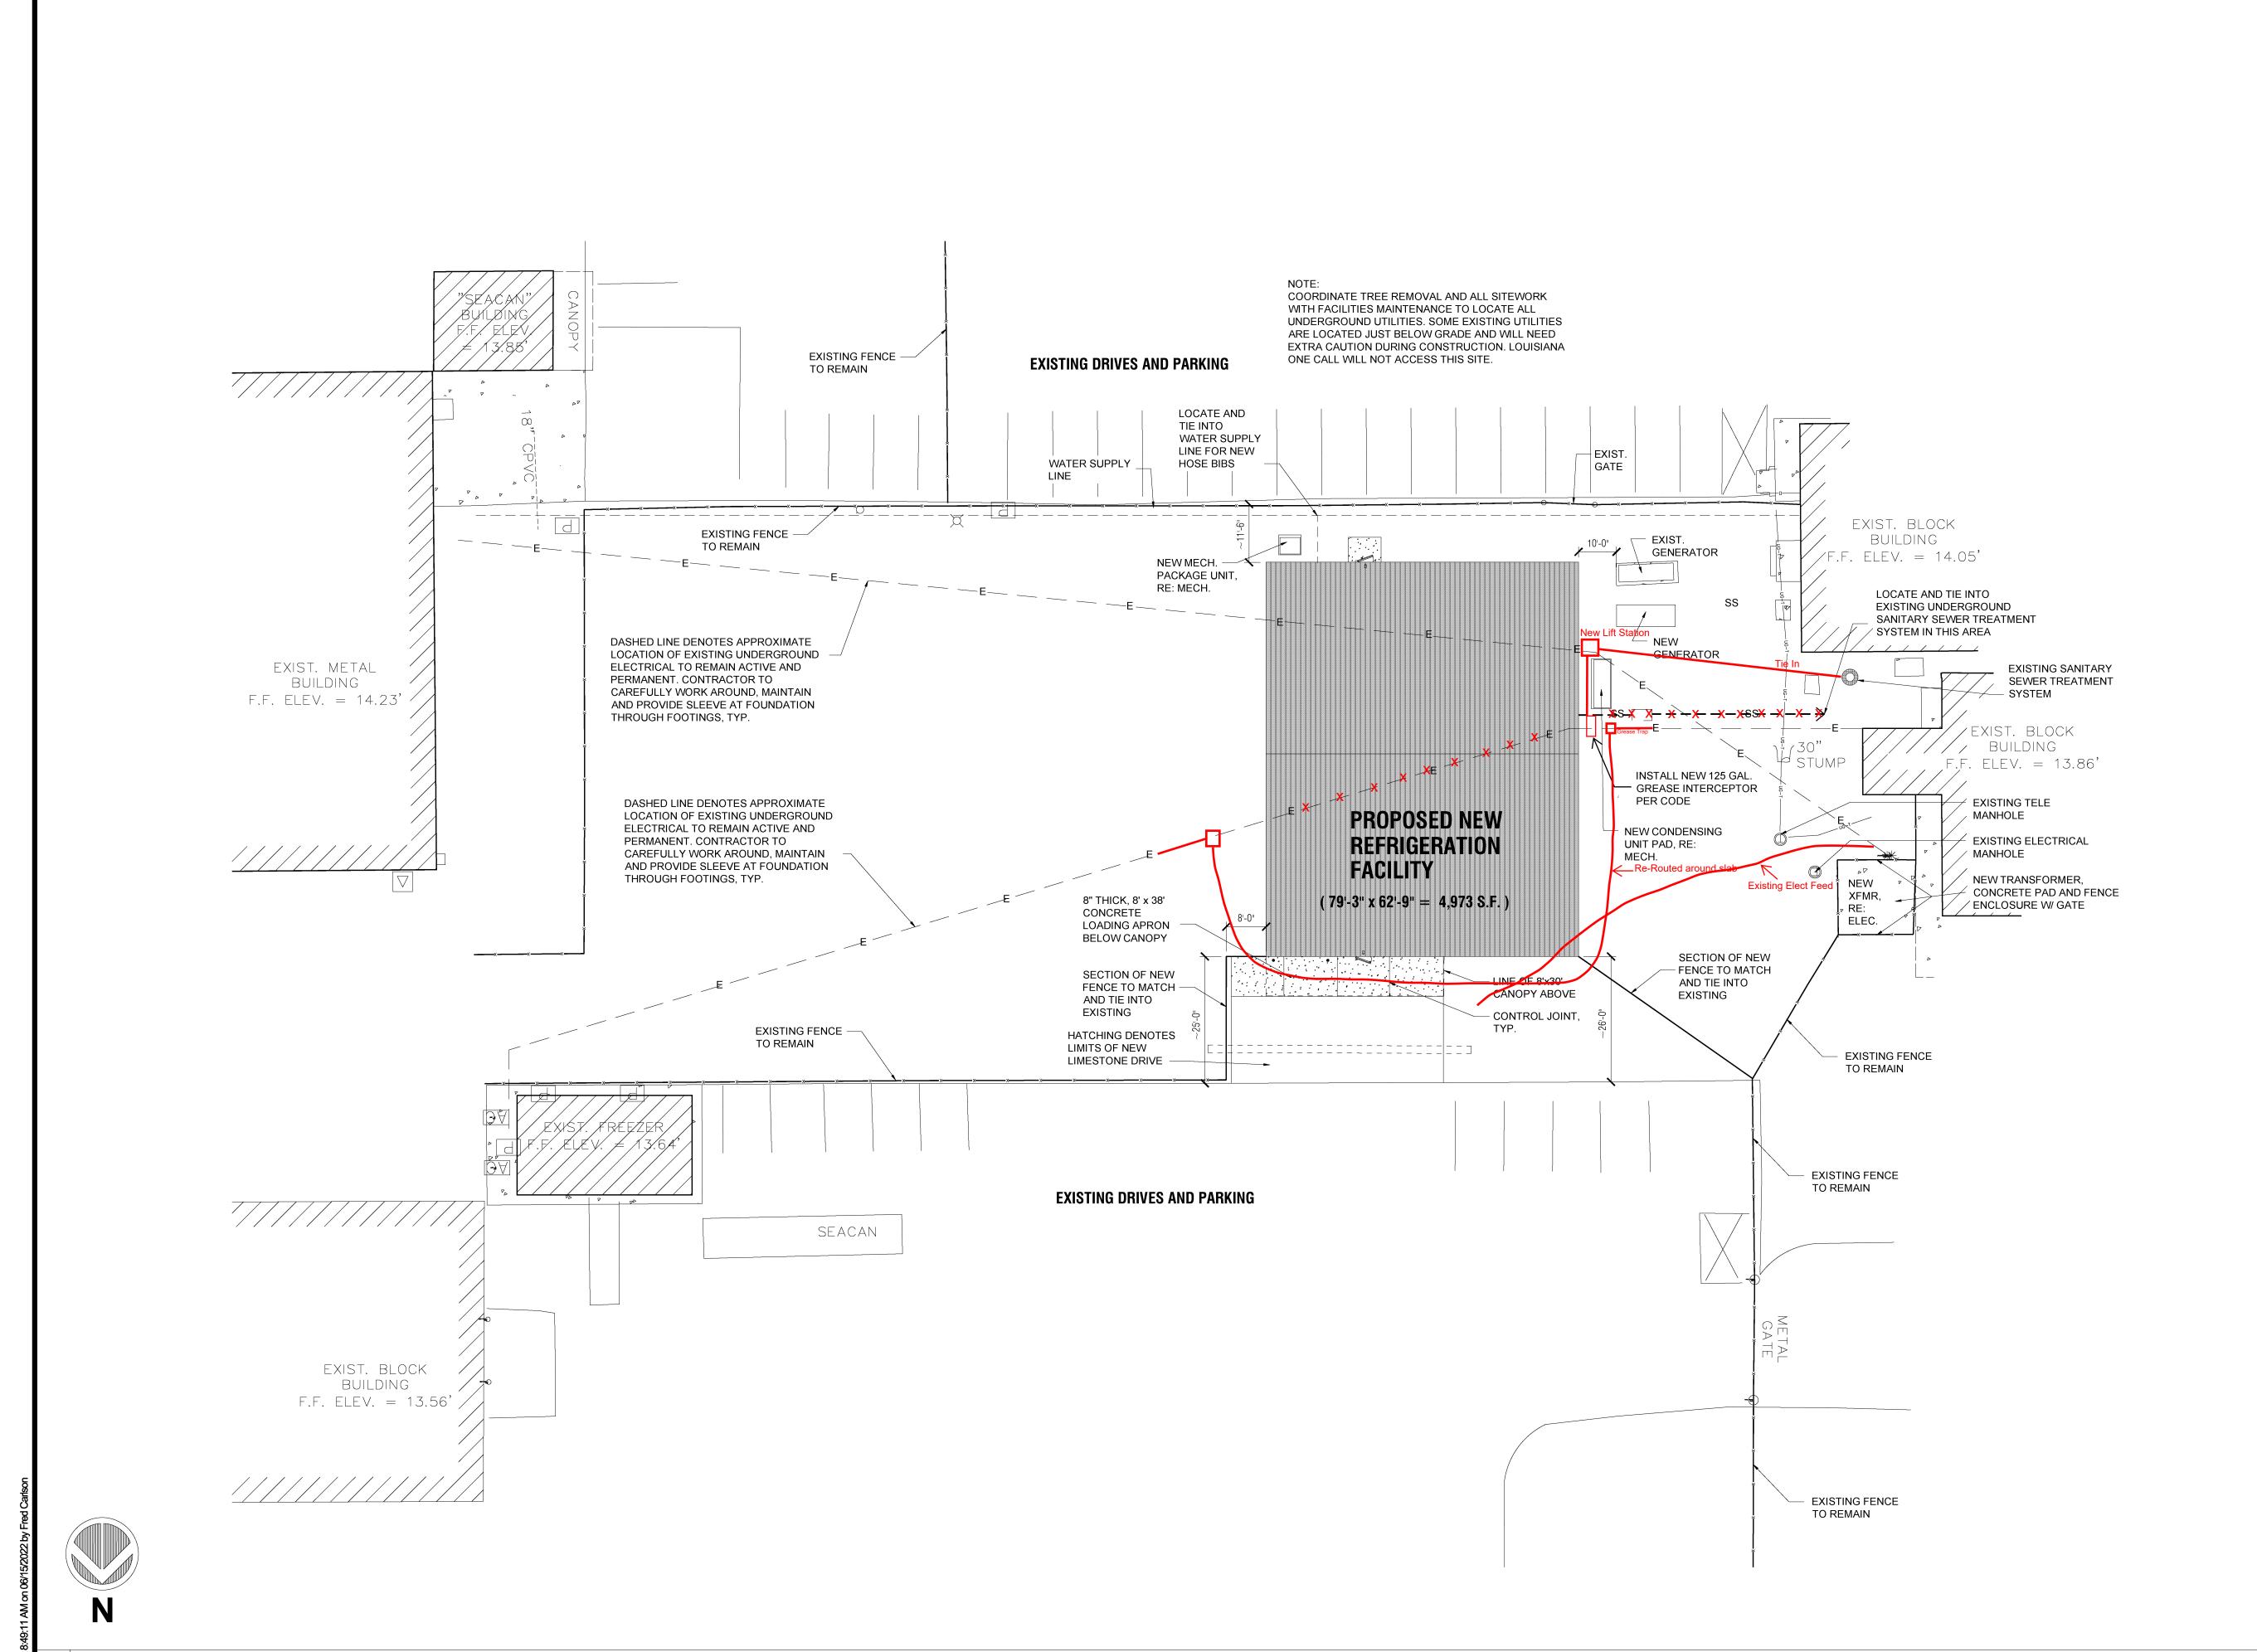

REVISION

Scale Note: Scale shown on sheets are accurate for 24x36 prints. Scale is halved for 18x24 prints.

ASE

New Cold Storage Building ELAYN HUNT CORRECTIONAL Department of Corrections

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Sheet No._

BID





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REVISIONS

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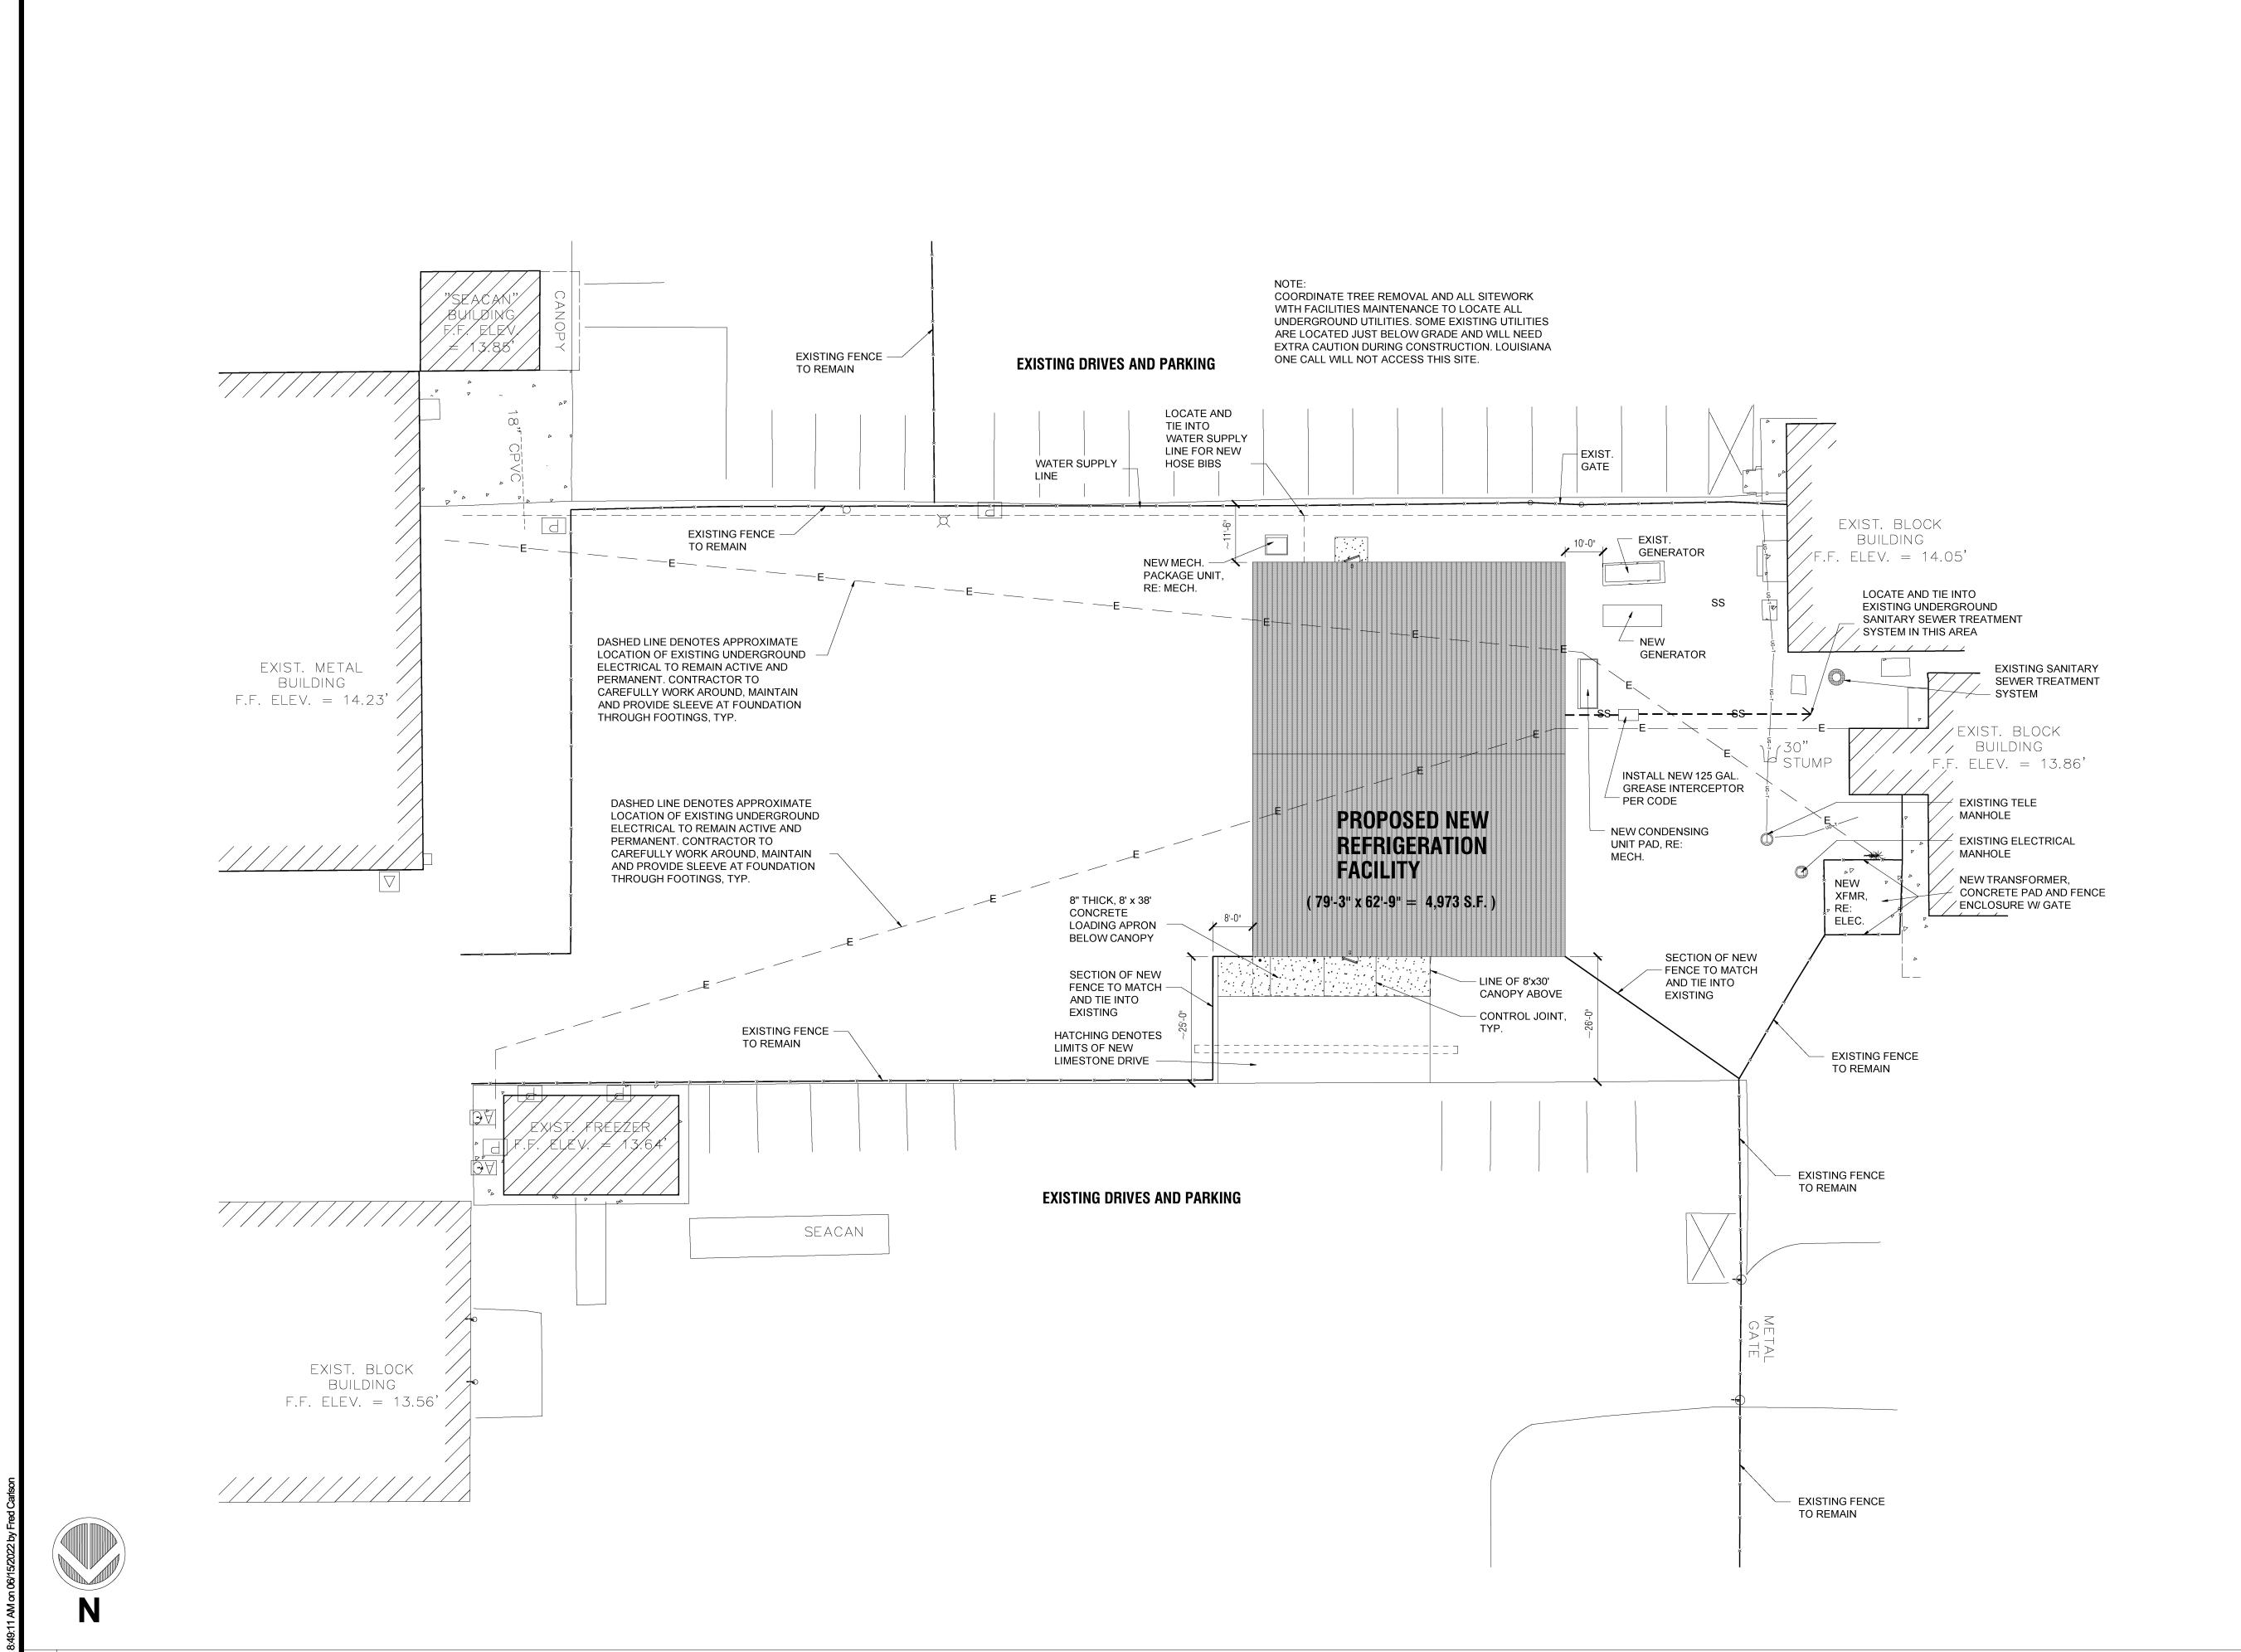
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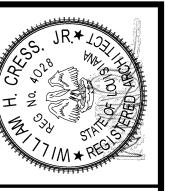
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BIDDING

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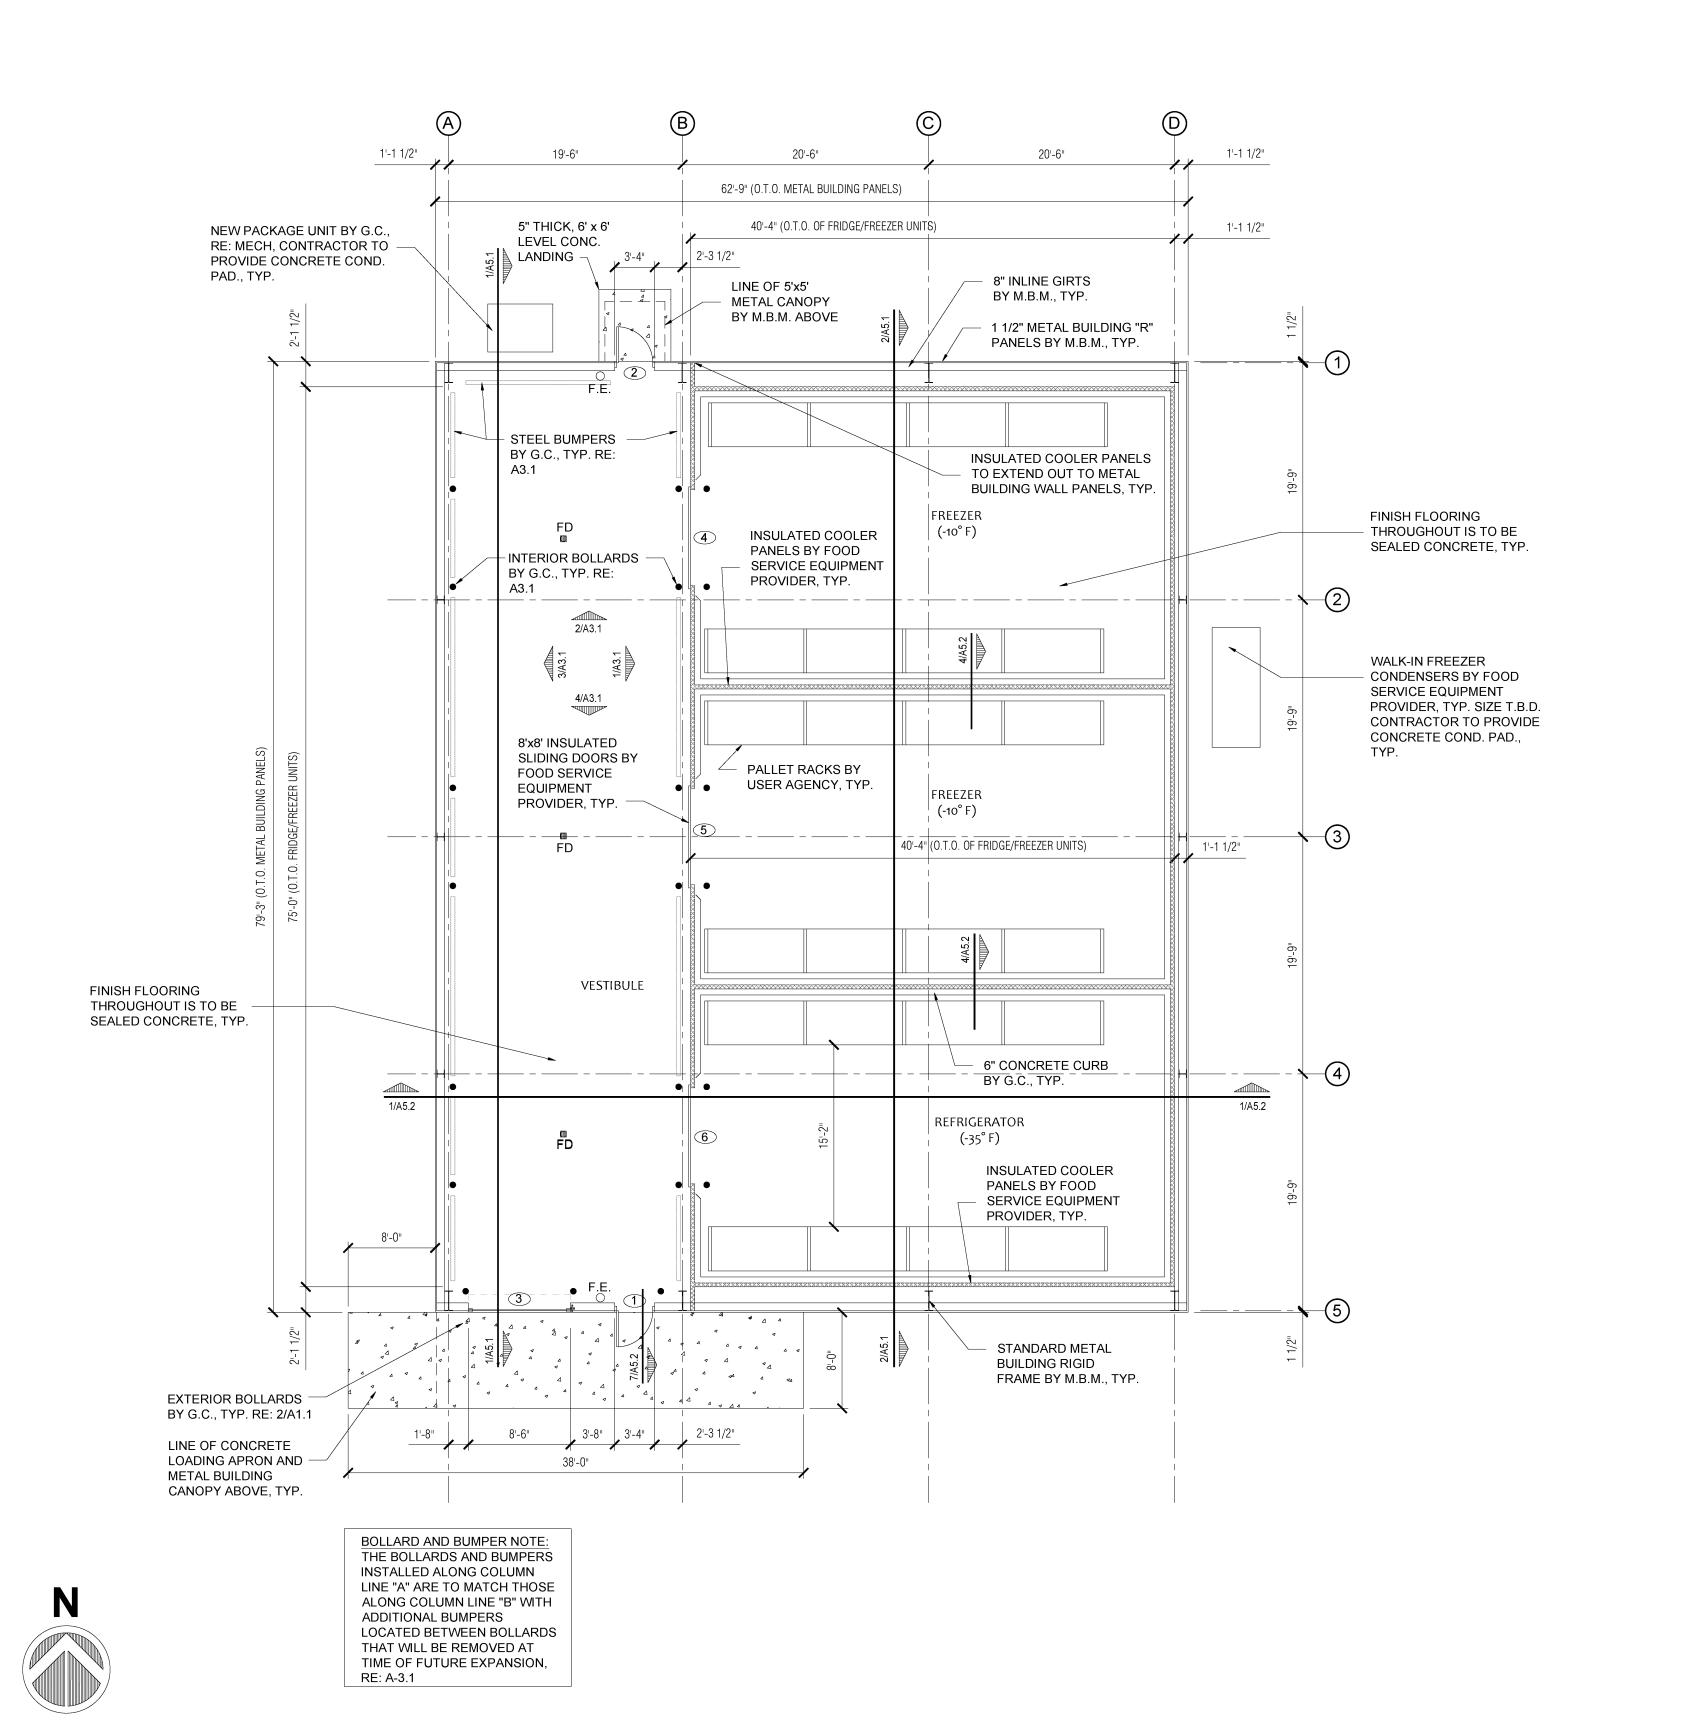
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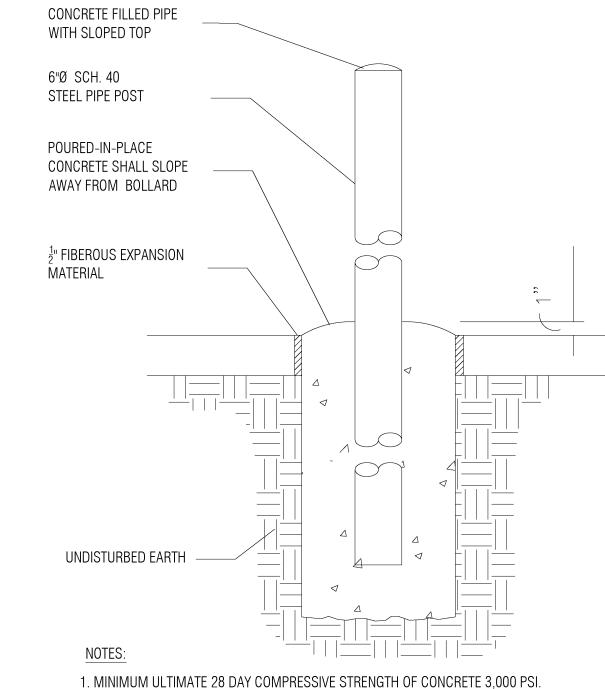
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ASE

New Cold Storage Building ELAYN HUNT CORRECTIONAL Department of Corrections

Sheet No.__ A-1.0





2. HOT-DIP GALVANIZE AFTER FABRICATION TO CONFORM WITH ASTM A123. 3. BOLLARDS TO BE PAINTED, CONCRETE FILLED STEEL, COLOR T.B.D.

2 EXTERIOR BOLLARD DETAIL SCALE: N.T.S.

R.#	SIZE	DESCR	RIPTION		Н	IAR	DW	ΆR	Ε								NOTES:
			0.7										LC	CKS	ΞT		
		<u>EXTERIOR</u> – INSULATED COILING O.H. DOOR W/ MANUAL OPENER	EXTERIOR—FLUSH INSULATED H.M. DOOR W/ H.M. WELDED FRAME. VERIFY COLOR WITH OWNER.	INTERIOR – FREEZER / COOLER DOOR. RE: FOOD SERVICE DRAWINGS	EXT. HINGES- NRP	INT. HINGES-	STOP-	CLOSER-	THRESHOLD —	WEATHERSTRIP -	DOOR BOTTOM -	PANIC HARDWARE -	PRIVACY –	LOCKSET -	PASSAGE -	HALF DUMMY —	
		Α	В	С													
1)	3-0 x 7-0		•		•		•	•	•	•		•		•			
2 :	3-0 x 7-0		•		•		•	•	•	•		•		•			
3	3-0 x 8-0	•								•							
4	RE: FOOD SERVICE DRAWING			•		•	RE	:: FO	OD S	ERVI	ICE D	RAW	ING				
5	RE: FOOD SERVICE DRAWING			•		RE: FOOD SERVICE DRAWING											
6	RE: FOOD SERVICE DRAWING			•			RE	:: FO	OD S	ERVI	ICE D	RAW	ING				

ALL REQUIRED EXTERIOR EGRESS DOORS TO HAVE CYLINDER W/ THUMB LATCH

VERIFY KEYING WITH USER AGENCY PRIOR TO BIDDING. CONFIRM AND PROVIDE ANY SPECIAL REQUIREMENTS FOR ACCESS CONTROL AND / OR OTHER DEVICES IF

7. CONTRACTOR TO PROVIDE SHOP DRAWINGS TO ARCHITECT FOR APPROVAL PRIOR TO CONSTRUCTION

NEEDED. VERIFY WITH OWNER IF THERE IS A BUILDING STANDARD.

VERIFY ALL HARDWARE AND KEYING WITH TENANT ALL EXTERIOR DOORS TO HAVE WEATHERSTRIPPING


ASE BID

1/8" = 1'-0

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DIMENSIONED FLOOR PLAN



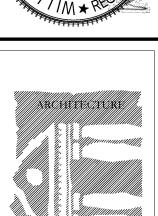


CRESS ARCHITA A PROFESSION/ 10606 COURS BATON ROUG (225) 930-604

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New Cold Storage Building ELAYN HUNT CORRECTIONAL Department of Corrections







CRESS & ARCHITE A PROFESSIONAL AR 10606 COURSEY 1 BATON ROUGE, 125) 930-6040
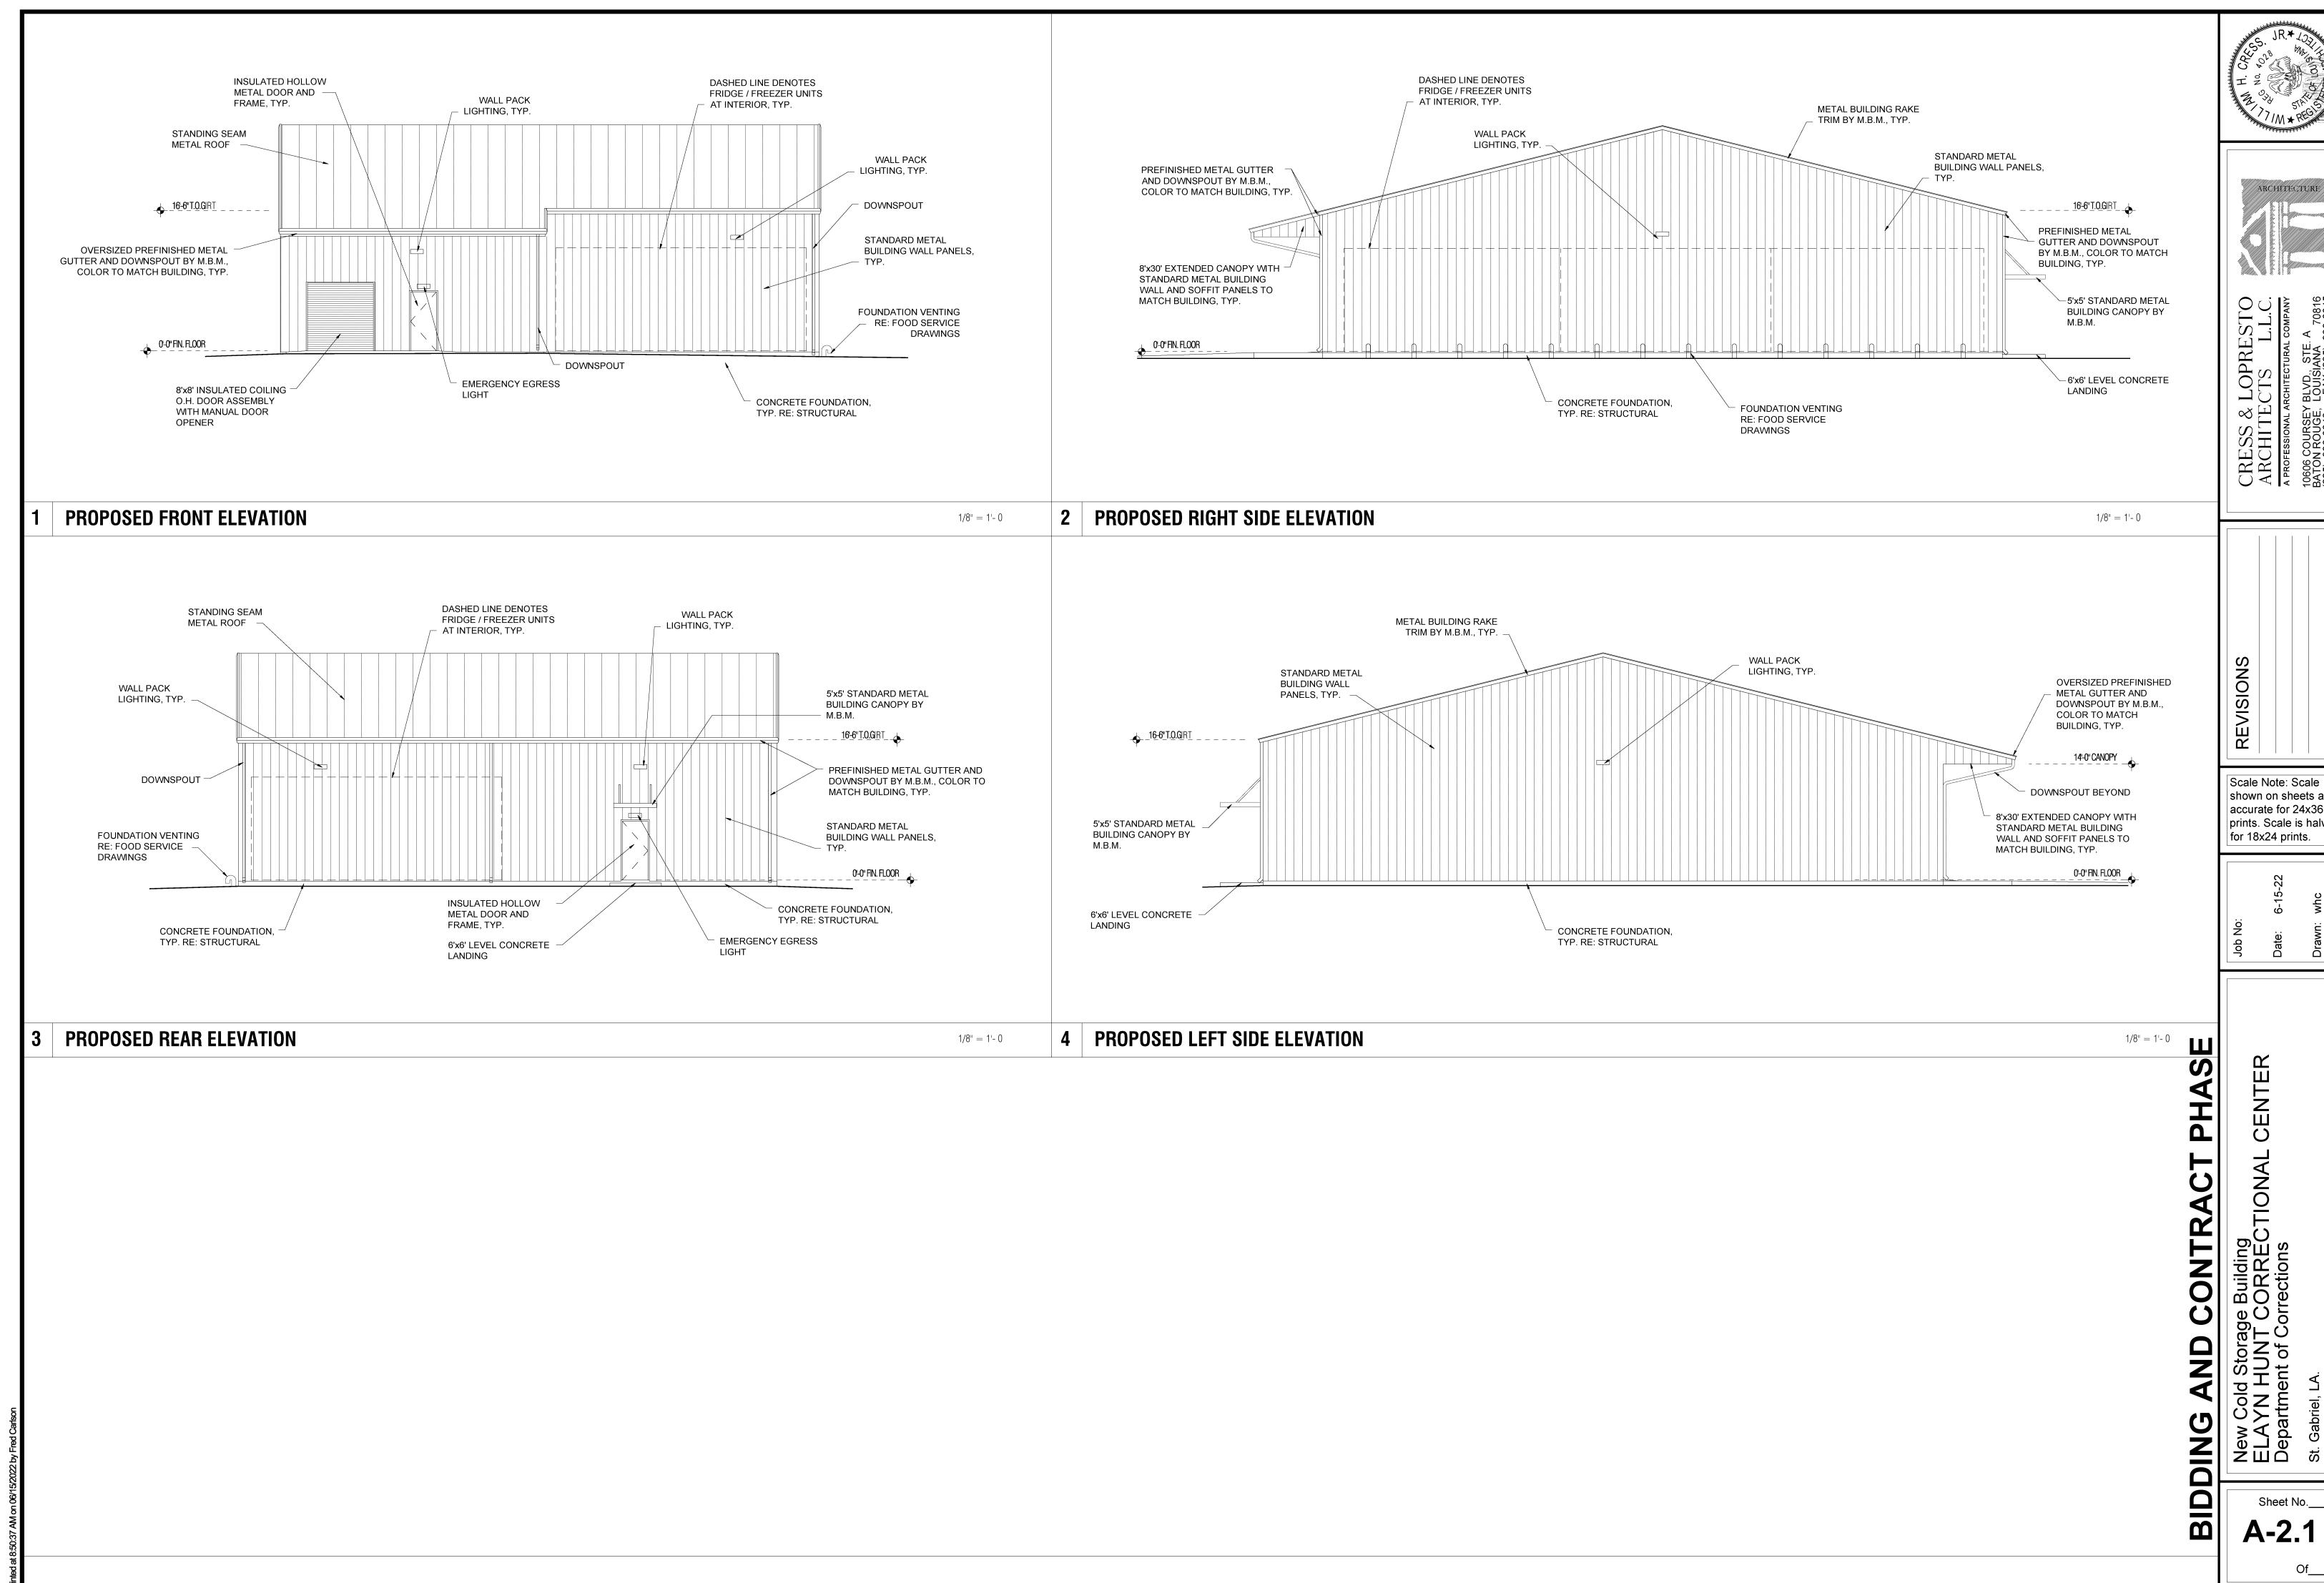
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CEILING SCH	HEDULE	
TYPE	LOCATION	DESCRIPTION
SUSPENDED ACOUSTICAL	VESTIBULE	CERAMAGUARD 605, 24"x24", WHITE SQUARE LAY-IN, PRELUDE XL 15/16" EXPOSED TEE GRID FOR EXTERIOR APPLICATIONS
INSULATED PANEL	FREEZERS, COOLERS	BY FOOD SERVICE EQUIPMENT PROVIDER

PHASE CONTRACT BIDDING

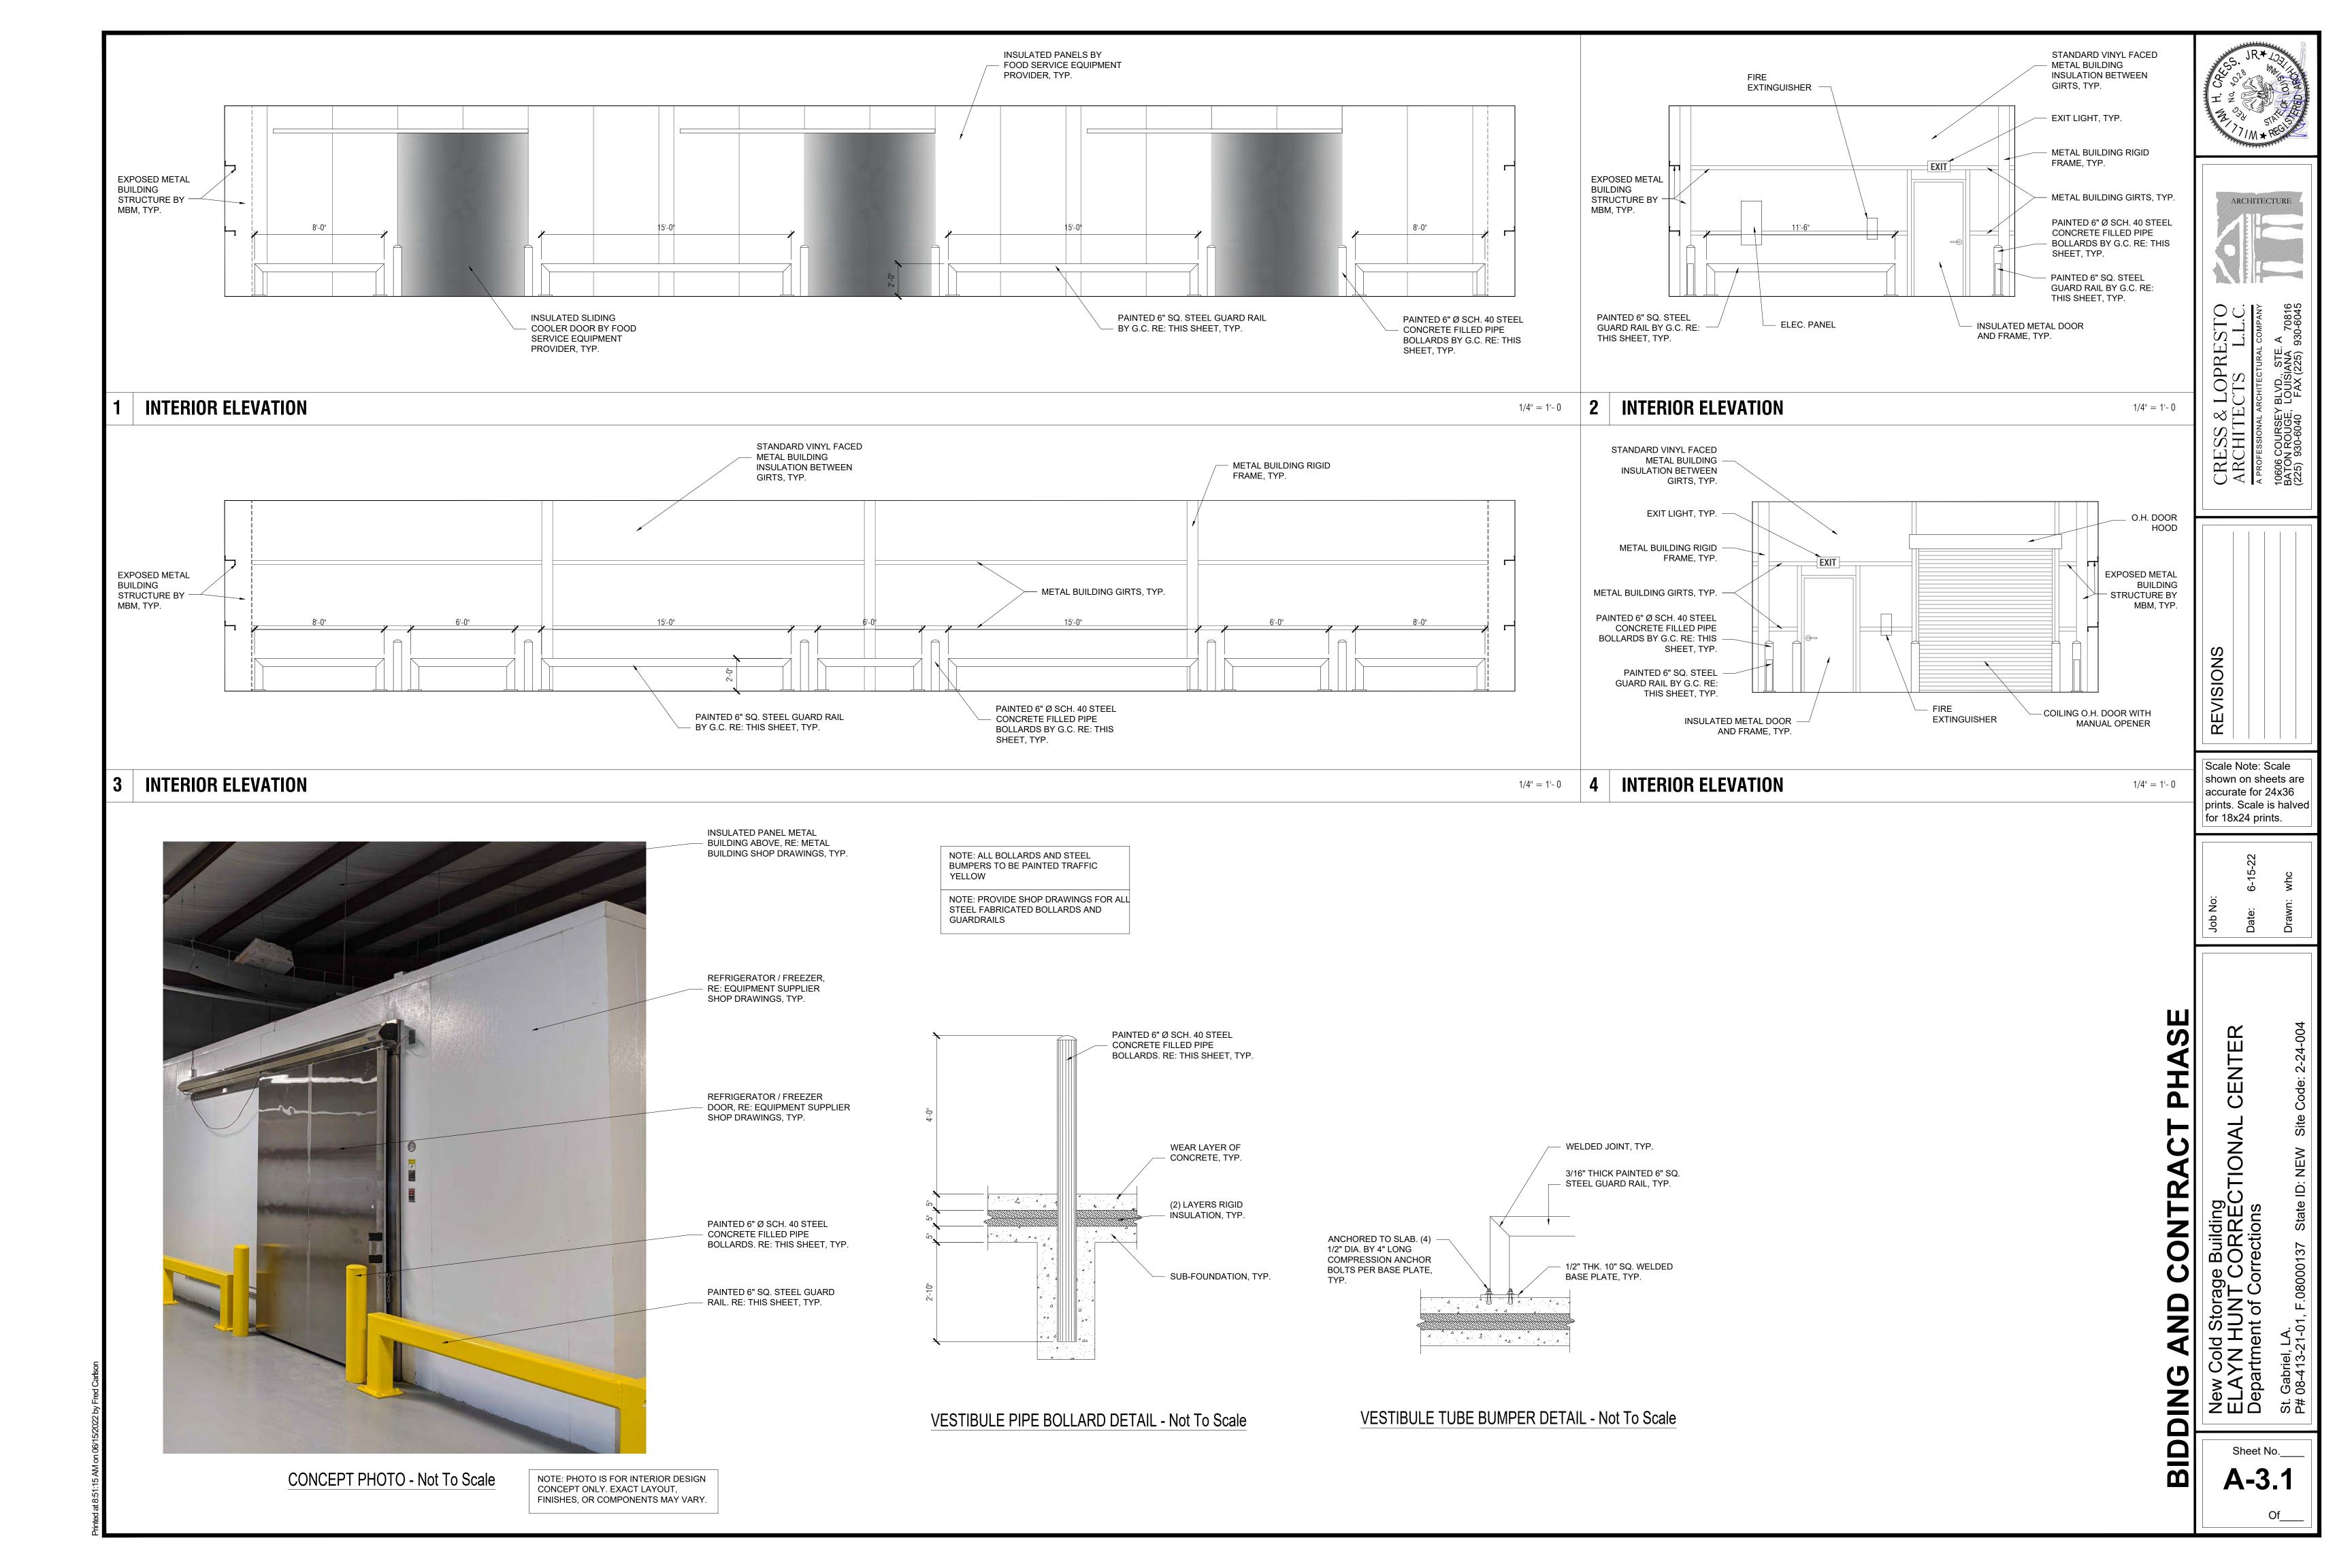CENTER New Cold Storage Building ELAYN HUNT CORRECTIONAL Department of Corrections

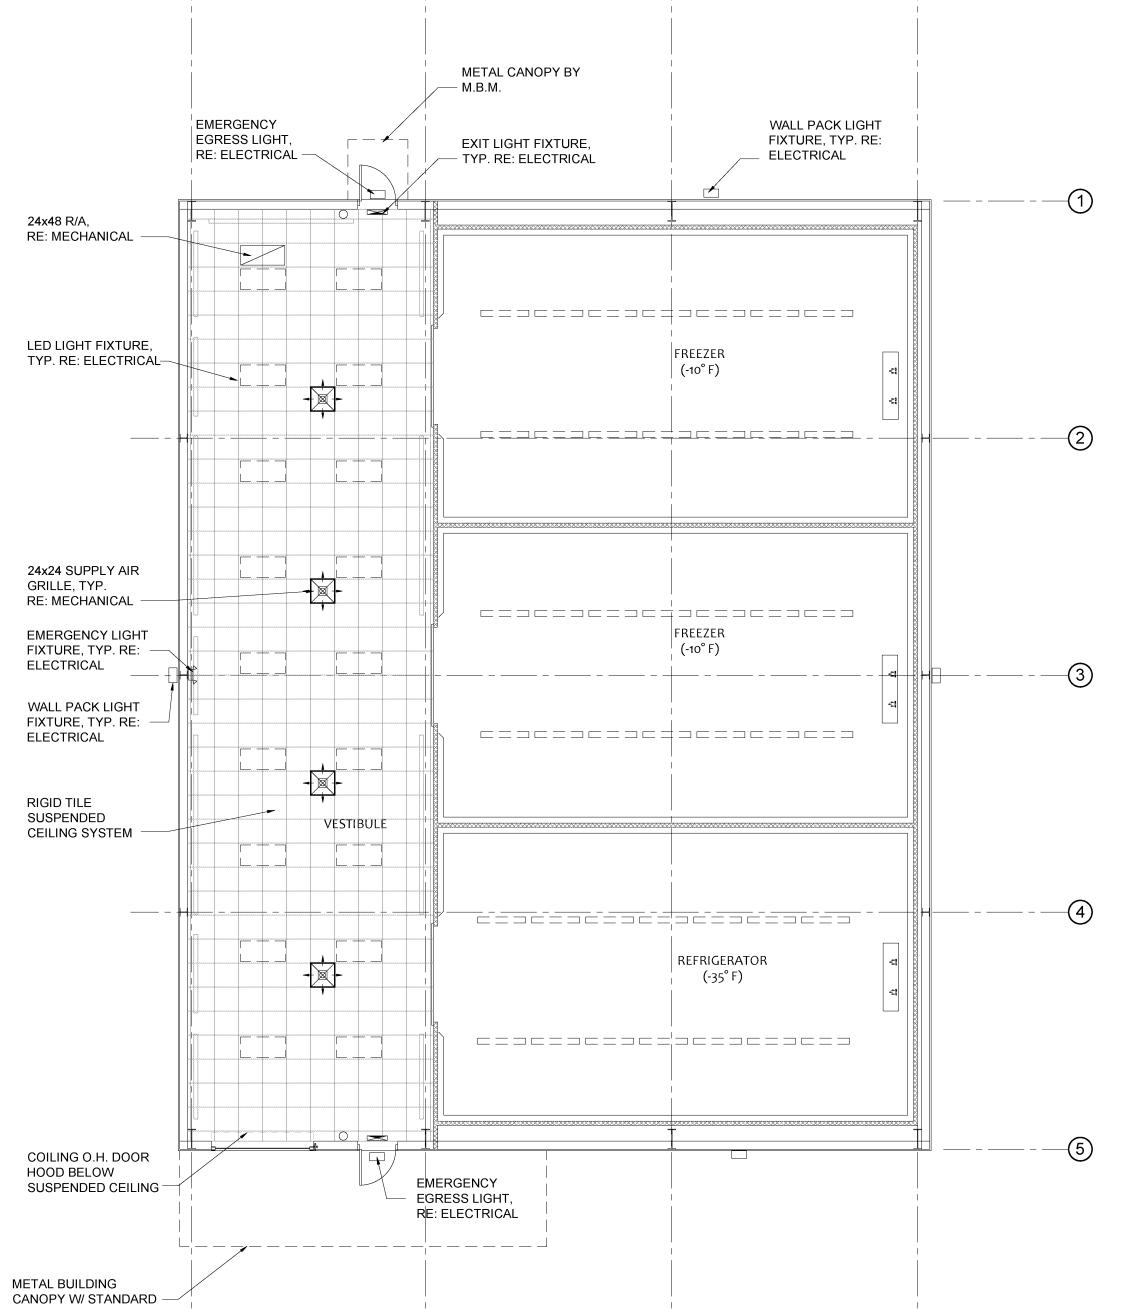REVISIONS

Scale Note: Scale shown on sheets are accurate for 24x36 prints. Scale is halved for 18x24 prints.

Sheet No._ **A-4.1**


Of____

PROPOSED REFLECTED CEILING PLAN

METAL BUILDING PANEL SOFFIT

1/8" = 1'-0

24x48 R/A, RE: MECHANICAL -LED LIGHT FIXTURE, TYP. RE: ELECTRICAL— 24x24 SUPPLY AIR GRILLE, TYP. RE: MECHANICAL — EMERGENCY LIGHT FIXTURE, TYP. RE: -ELECTRICAL WALL PACK LIGHT FIXTURE, TYP. RE: ELECTRICAL RIGID TILE SUSPENDED CEILING SYSTEM COILING O.H. DOOR HOOD BELOW SUSPENDED CEILING —

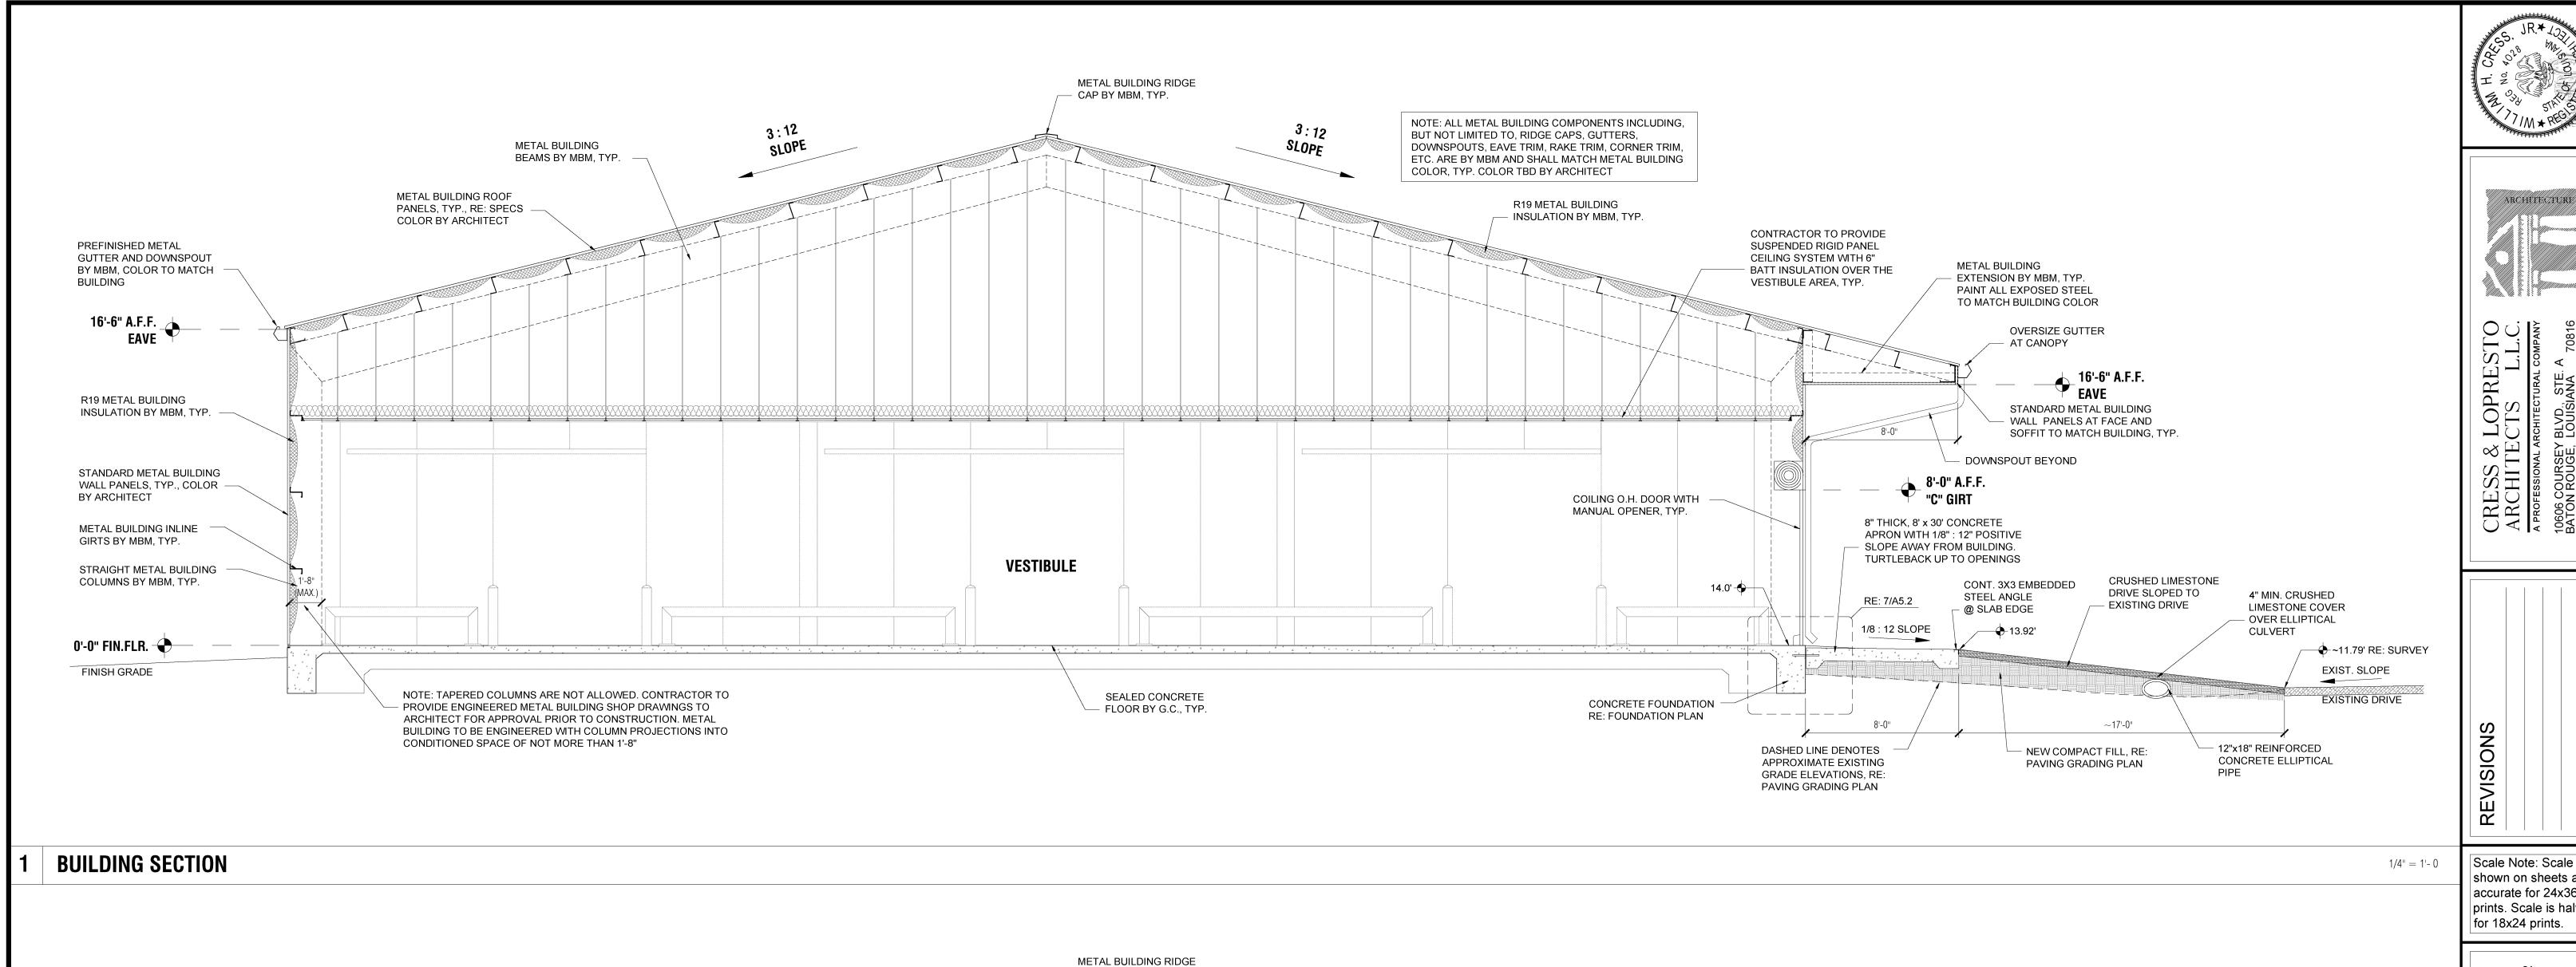

SLOPE

CAP BY MBM, TYP.

REFRIGERATOR AND FREEZER ROOF

PANELS TO BE SUSPENDED FROM

STRUCTURE ABOVE. CONTRACTOR

SHALL COORDINATE WITH MBM TO

INCLUDE ALL LOADS WITHIN METAL

ASPECTS

VENT PIPING

FREEZER

NOTE: ALL FREEZER EQUIPMENT IS

PROVIDED AND INSTALLED BY EQUIPMENT SUPPLIER. G.C. TO COORDINATE ALL

BUILDING DESIGN

METAL BUILDING ROOF

COLOR BY ARCHITECT

METAL BUILDING INLINE

STRAIGHT METAL BUILDING

COLUMNS BY MBM, TYP.

GIRTS BY MBM, TYP.

PREFINISHED METAL

BUILDING

GUTTER AND DOWNSPOUT

BY MBM, COLOR TO MATCH

12'-0" A.F.F. T.O.FREEZER

RE: 5/A5.2

STANDARD METAL BUILDING

WALL PANELS, TYP., COLOR

BY ARCHITECT

FINISH GRADE

PANELS, TYP., RE: SPECS

FREEZER

METAL BUILDING

BEAMS BY MBM, TYP.

Scale Note: Scale shown on sheets are accurate for 24x36 prints. Scale is halved for 18x24 prints.

Building CORRECTIONAL rrections

Sheet No._

BUILDING SECTION 1/4" = 1'-0

RE: 4/A5.2

REFRIGERATOR AND FREEZER ROOF

PANELS TO BE SUSPENDED FROM STRUCTURE ABOVE. CONTRACTOR SHALL COORDINATE WITH MBM TO

INCLUDE ALL LOADS WITHIN METAL

R19 METAL BUILDING

INSULATION BY MBM, TYP.

16'-6" A.F.F. EAVE

R19 METAL BUILDING

CONCRETE FOUNDATION

RE: FOUNDATION PLAN

RE: 5/A5.2 (MIRRORED)

INSULATION BY MBM, TYP.

BUILDING DESIGN


REFRIGERATOR

SEALED CONCRETE FLOOR BY G.C., TYP.

REFRIGERATOR AND

SHOP DRAWINGS


FREEZER RE: EQUIPMENT

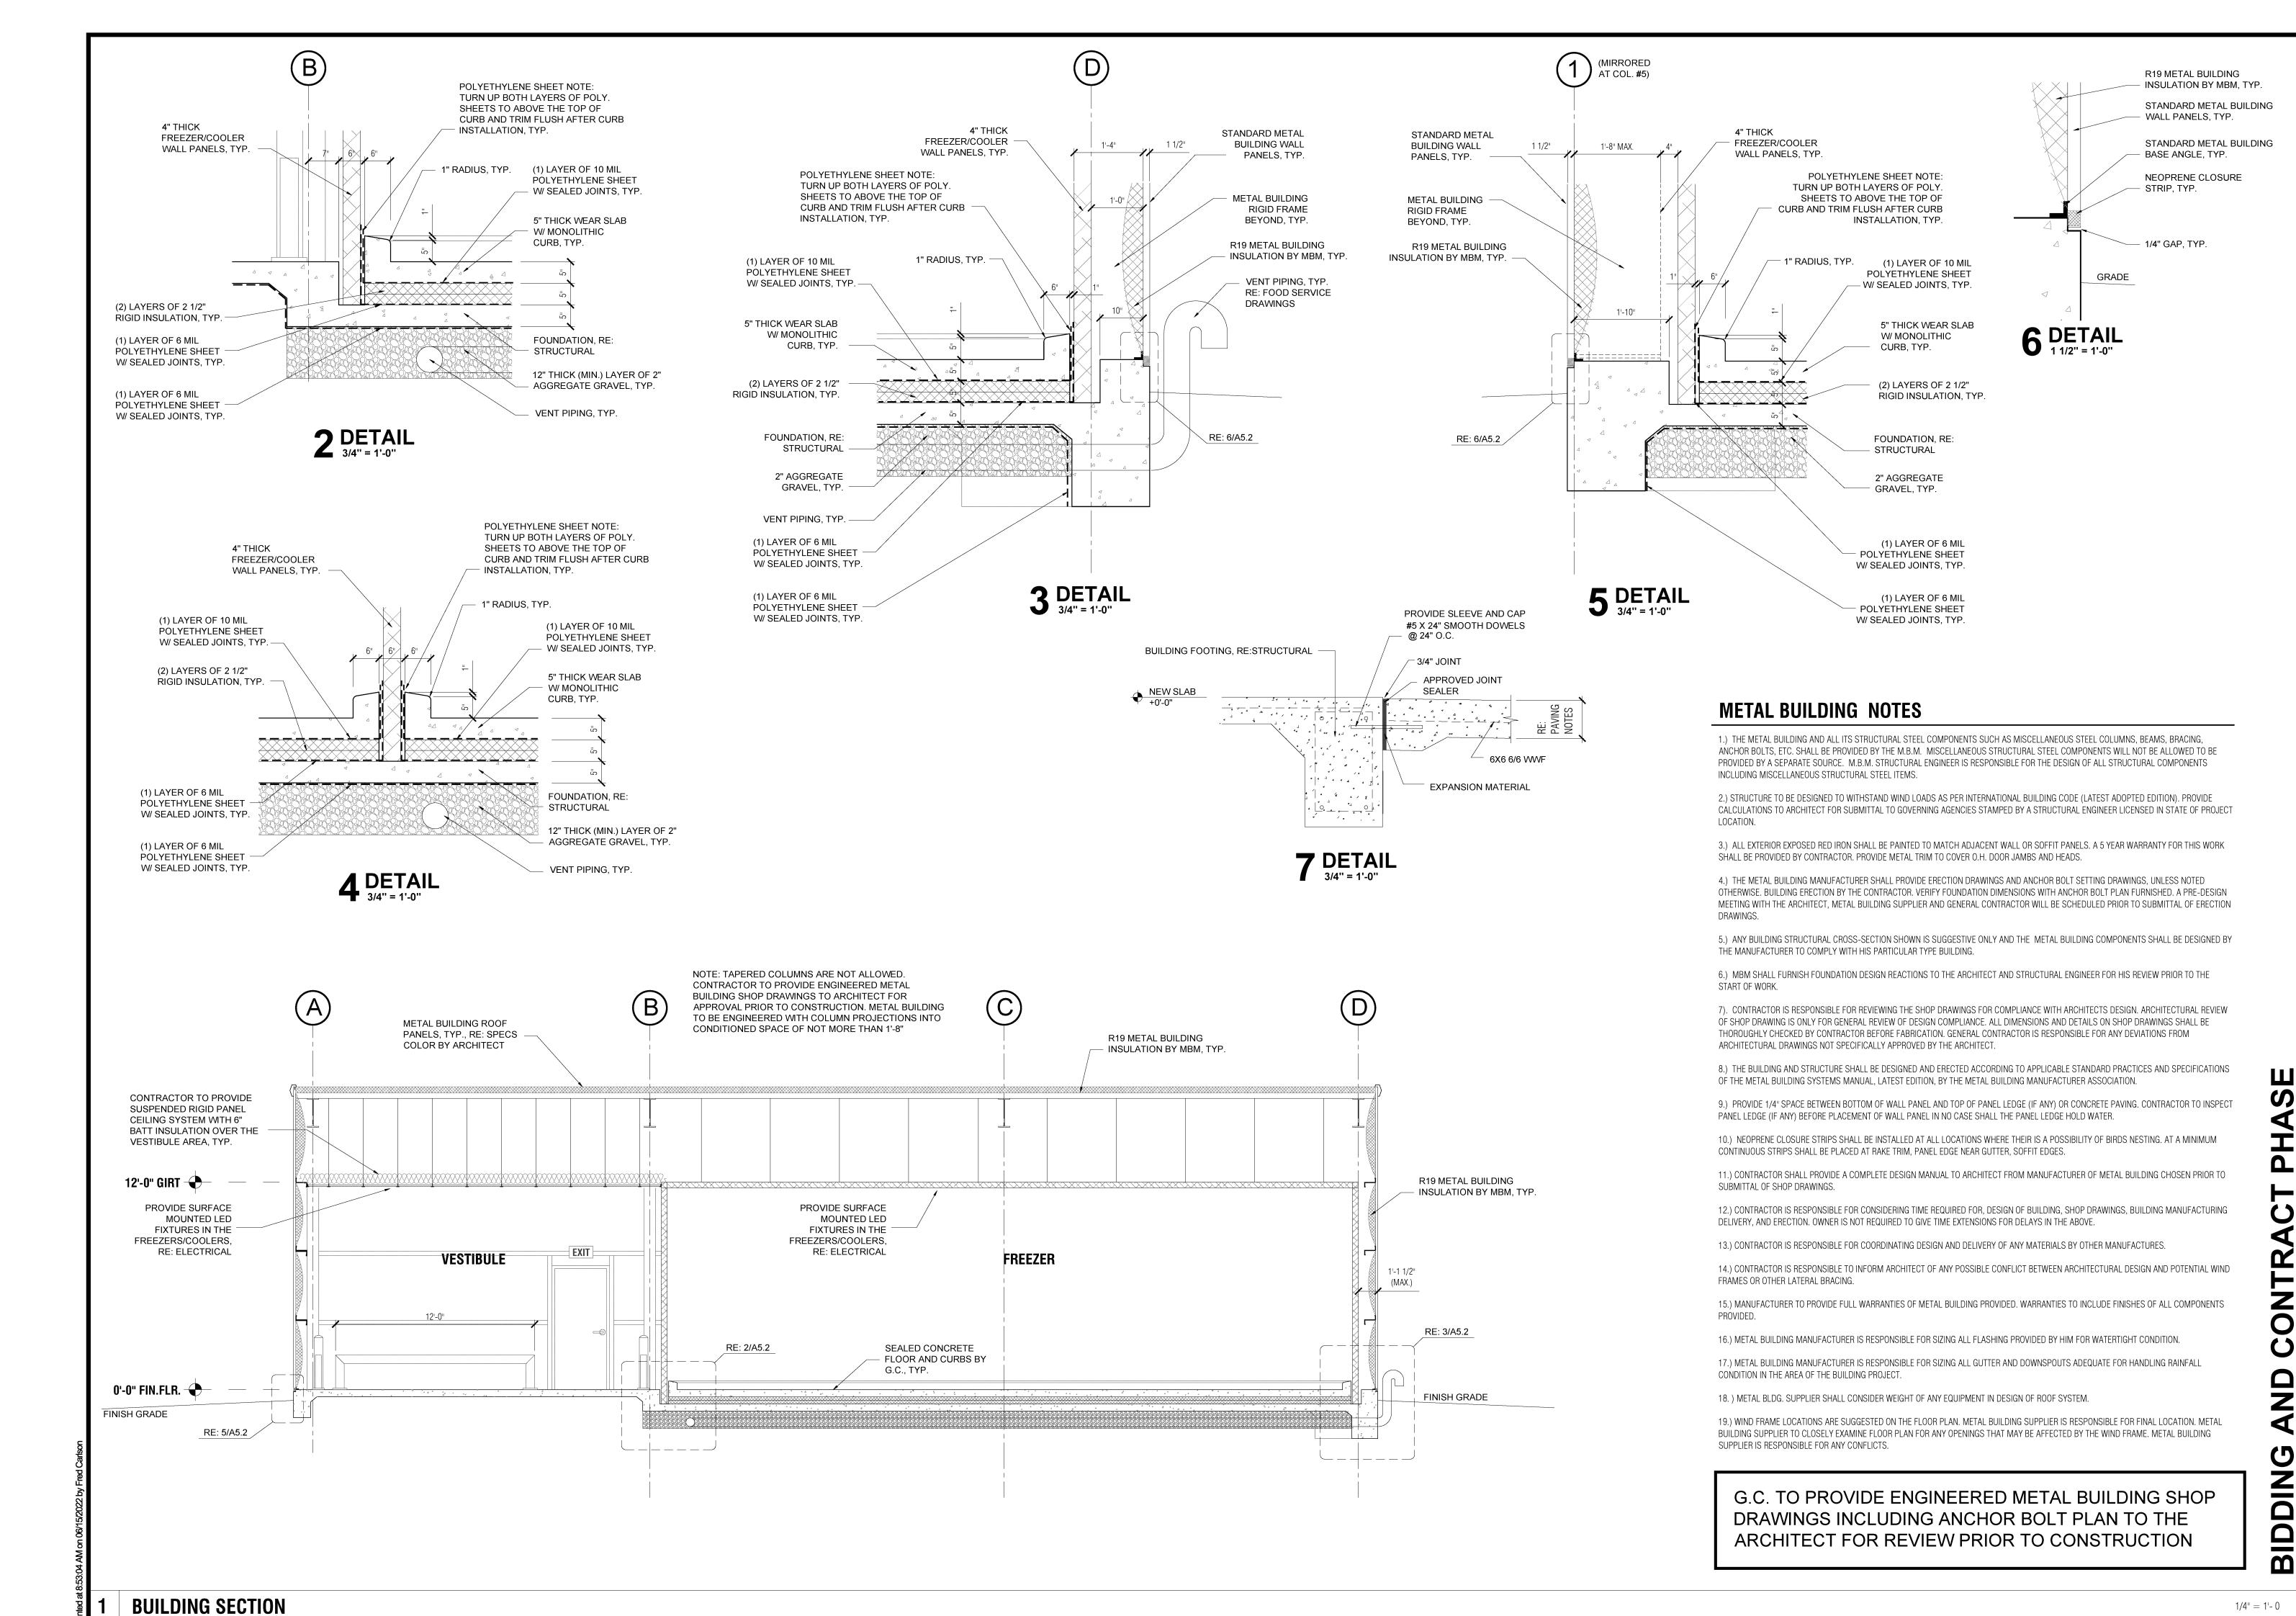


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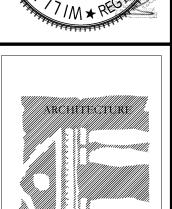
Scale Note: Scale shown on sheets are accurate for 24x36 prints. Scale is halved for 18x24 prints.



NOTE: CONTRACTOR/OWNER SHALL BE RESPONSIBLE FOR PLUMBING SYSTEM FINAL DESIGN AND IMPLEMENTATION. THIS FIRM - NOT BEING AN ENGINEERING FIRM - STANDS NO LIABILITY FOR FINAL DESIGN AND IMPLEMENTATION OF PLUMBING SYSTEM. CONTRACTOR/OWNER SHALL BE RESPONSIBLE FOR SUBMITTING ALL CORRECT INFORMATION REQUIRED FOR PERMITTING AND FOR CONSTRUCTION. EVERY EFFORT SHALL BE MADE BY THE CONTRACTOR/OWNER TO ENSURE THAT ALL GOVERNING REGULATIONS HAVE BEEN MET.

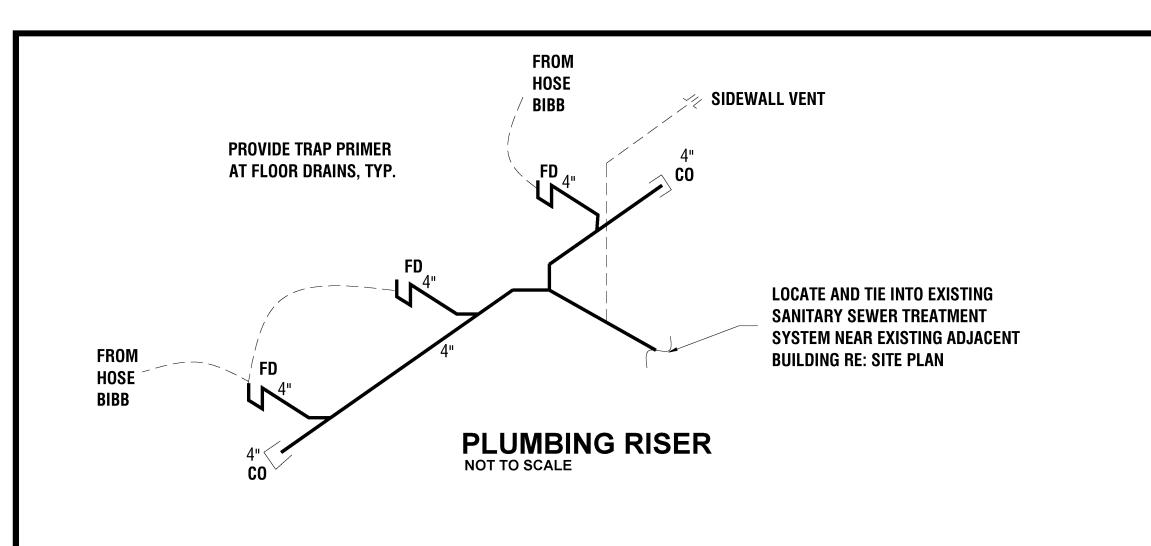



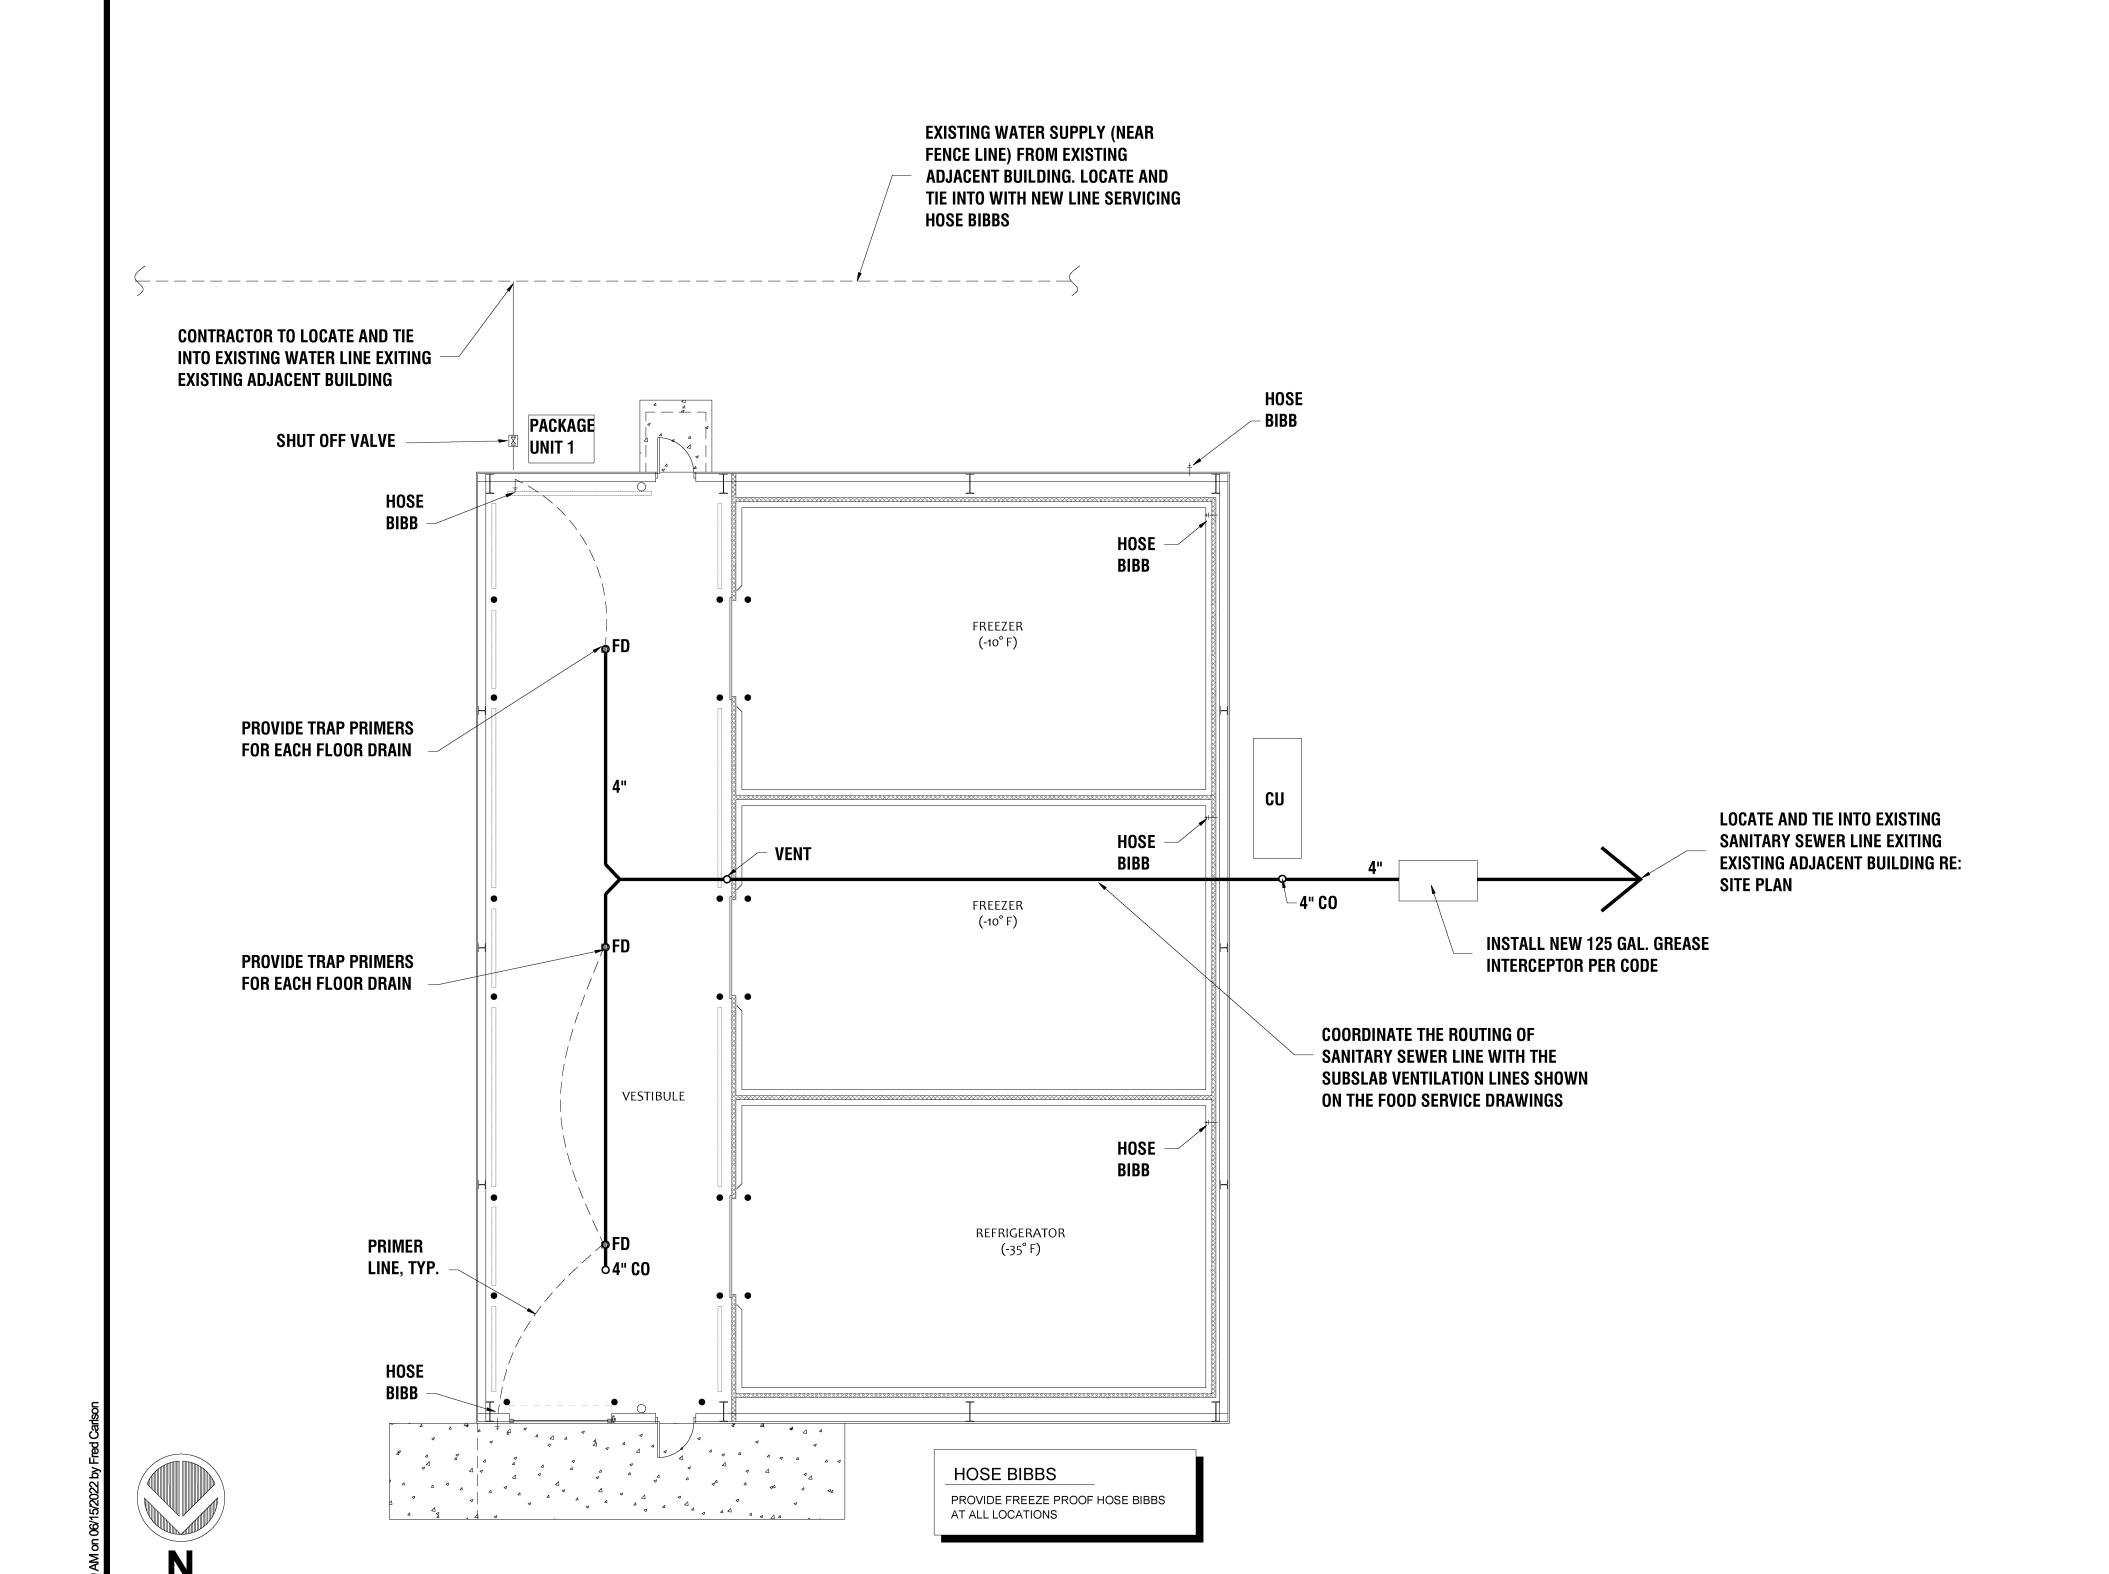

REVISIONS

Scale Note: Scale shown on sheets are accurate for 24x36 prints. Scale is halved for 18x24 prints.

CENTER

PHASE

New Cold Storage Building ELAYN HUNT CORRECTIONAL Department of Corrections

1. WATER HAMMER ARRESTORS AND BACKFLOW PREVENTORS SHALL BE INSTALLED ON ALL PLUMBING FIXTURES AS REQUIRED BY IPC AND EQUIPMENT MANUFACTURER'S REQUIREMENTS.

2. ALL PLUMBING FIXTURES SHALL BE LEAD FREE, NO EXCEPTIONS.

GENERAL PLUMBING PLAN NOTES:

CONTRACTOR SHALL INSTALL SANITARY SEWER CLEANOUTS EVERY 75'-0" ON CENTER ON ALL NEW SANITARY SEWER PIPING ON SITE, IF NOT ALREADY SHOWN ON PLANS.

2. ALL NEW SANITARY SEWER PIPING SHALL BE SLOPED AT 1/8" FALL PER LINEAR FOOT AS PER THE LOUISIANA STATE PLUMBING CODE. CONTRACTOR SHALL BE NO EXTRA CHARGE TO THE OWNER FOR UTILITY CONNECTION AFTER TIME OF BID. REFER TO CIVIL FOR WATER METER. CONTRACTOR SHALL INSTALL NEW BACKFLOW PREVENTOR FOR FREEZE PROTECTION. PLUMBING CONTRACTOR SHALL INSTALL THE ABOVE MENTIONED BACKFLOW PREVENTOR ABOVE GRADE AND IN THE VICINITY OF THE WATER METER. PLUMBING CONTRACTOR SHALL BE PERFORMED BY AN INDIVIDUAL WHO MEETS ASSE 5000 PROFESSIONAL QUALIFICATION STANDARD AND HAS A TESTING CERTIFICATE FROM A NATIONALLY RECOGNIZED BACKFLOW CERTIFICATION ORGANIZATION APPROVED BY THE STATE OF LOUISIANA, DEPARTMENT OF HEALTH AND HOSPITALS. ALL SANITARY SEWER PIPING BELOW SLAB SHALL BE SCHEDULE 40 PVC. REFER TO SPECIFICATIONS.

ALL DOMESTIC WATER LINES 5'-0" FROM BUILDINGS SHALL BE SCHEDULE 40 PVC WITH SOLVENT WELD JOINTS.

CONTRACTOR SHALL FIELD VERIFY THE EXACT LOCATION OF ALL EXISTING UTILITIES, INCLUDING SANITARY SEWER AND DOMESTIC WATER PRIOR TO BEGINNING WORK.

THE SUBMISSION OF PROPOSAL BY THE CONTRACTOR WILL BE CONSTRUED AS EVIDENCE THAT THE CONTRACTOR HAS FAMILIARIZED HIMSELF WITH THE ENTIRE CONSTRUCTION PLANS & BUILDING SITE. CLAIMS MADE SUBSEQUENT TO THE PROPOSAL FOR MATERIALS & LABOR BECAUSE OF DIFFICULTIES ENCOUNTERED DUE TO EXISTING JOBSITE CONDITIONS WILL NOT BE RECOGNIZED HAD PROPER EXAMINATION BEEN MADE. CONTRACTOR SHALL PROVIDE AND INSTALL ALL NECESSARY PIPING OFFSETS/TRANSITIONS/PIPING TO ACCOMMODATE INSTALLATION OF ALL CW, SANITARY SEWER, AND VENT PIPING WITH STRUCTURAL. THIS SHALL INCLUDE ALL ADDITIONAL MISCELLANEOUS ITEMS. NO CHANGE ORDERS SHALL BE GIVEN FOR THESE ITEMS. ALL DOMESTIC COLD WATER SHUT OFF VALVES LOCATED ABOVE THE CEILING WILL BE IDENTIFIED WITH 1" WIDE RED REFLECTIVE TAPE, WRAPPED TWO (2) COMPLETE TURNS AROUND THE CEILING GRID WITH THE CUT END OF THE TAPE CONCEALED ABOVE THE CEILING AND WILL BE LOCATED DIRECTLY BELOW EACH VALVE.


DOMESTIC WATER SHALL BE RUN A MINIMUM OF 36" BELOW FINISHED GRADE.

10. SUPPLY SYSTEMS SHALL USE DIELECTRIC ADAPTERS WHERE PIPES OF DISSIMILAR METALS ARE BEING CONNECTED.


11. IN ADDITION TO THE TEST CALLED FOR IN THE SPECIFICATIONS, THE POTABLE WATER SYSTEM SHALL BE PROPERLY DISINFECTED IN ACCORDANCE WITH FEDERAL SPECIFICATION, THE CONTRACTOR SHALL SUBMIT WATER SAMPLES TO THE LOCAL HEALTH DEPARTMENT FOR TESTING AND APPROVAL. LOCAL HEALTH DEPARTMENT APPROVAL MUST BE ATTAINED 12. PLUMBING CONTRACTOR SHALL REVIEW ALL CONSTRUCTION DOCUMENTS PRIOR TO BIDDING, ORDERING AND INSTALLING AND SHALL BRING TO THE ATTENTION OF THE

ARCHITECT ANY DISCREPANCIES OR CONFLICTS FOR RESOLUTION PRIOR TO ORDERING OR BEGINNING ANY WORK. NO CHANGE ORDERS SHALL BE GIVEN. 13. ALL DOMESTIC WATER, SANITARY, VENT PIPING SHALL BE SLEEVED THROUGH WALLS; SLEEVES SHALL BE SIZED TO ALLOW PASSAGE OF THE PIPE AND ITS FULL INSULATION THICKNESS PLUS ANNULAR SPACE FOR INSTALLATION OF SAFING AND/OR SEALANT AS REQUIRED.

14. ALL UNDERGROUND NON-CONDUCTIVE PIPE SHALL BE INSTALLED WITH #10 COPPER WIRE SET WITH THE PIPE. ALL UNDERGROUND NON-CONDUCTIVE PIPING OUTSIDE THE BUILDING SHALL HAVE BRIGHTLY-COLORED, METALLIC-CORE, WHICHEVER DIMENSION IS SHALLOWER.

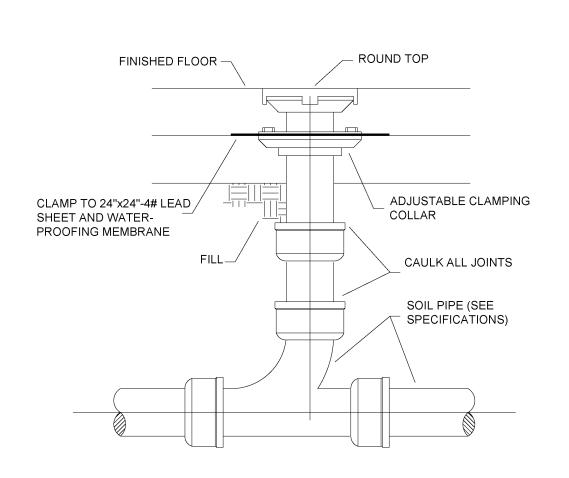


DETAIL - INTERIOR FLOOR CLEANOUT SCALE: NO SCALE

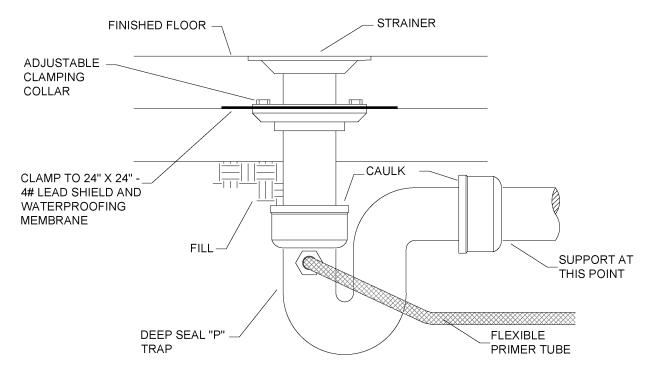


ALL FLOOR DRAINS SHALL HAVE TRAP PRIMERS, NO EXCEPTIONS.

FLOOR DRAINS LOCATED INSIDE MECHANICAL ROOMS SHALL BE COORDINATED WITH ALL PLUMBING AND MECHANICAL EQUIPMENT AND SHALL BE SHIFTED AS NECESSARY TO PREVENT ANY PART OF FLOOR DRAIN FROM BEING COVERED UP OR CONCEALED. WHERE THE MECHANICAL ROOMS ARE RETURN AIR PLENUM SPACES, THE FLOOR DRAINS SHALL BE ENCLOSED INSIDE A STAINLESS STEEL BOX WITH GASKETED HINGED ACCESS PANEL/DOOR

> DETAIL - FLOOR DRAIN SCALE: NO SCALE

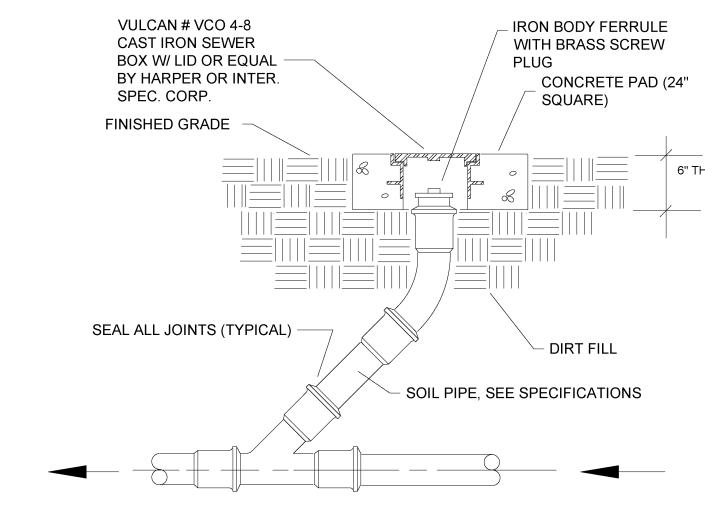


DETAIL - EXTERIOR CLEANOUT SCALE: NO SCALE

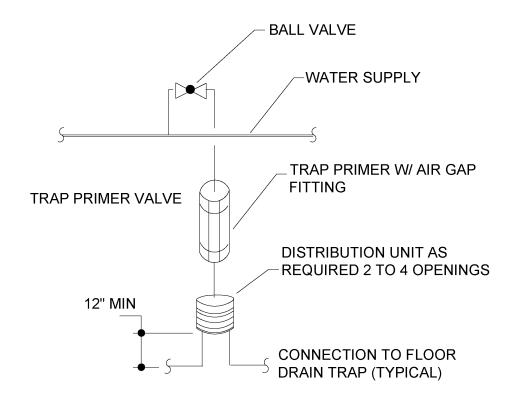

PROVIDE PROPER BACKFLOW PREVENTION DEVICES IF IT IS CONNECTED TO THE POTABLE WATER SUPPLY LINE. TRAP PRIMERS SHALL BE INSTALLED ON ALL FLOOR DRAINS, TYPICAL.

> DETAIL - TRAP PRIMER SCALE: NO SCALE

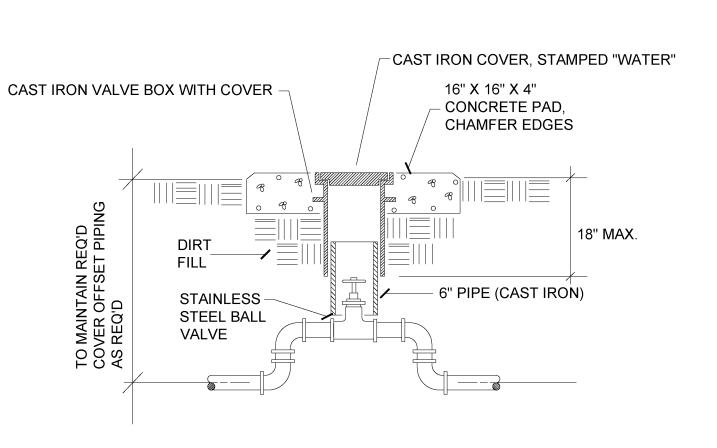


DETAIL - VALVE BOX FOR DOMESTIC WATER SERVICE SCALE: NO SCALE




BID

Sheet No._

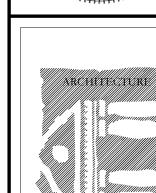

RESS

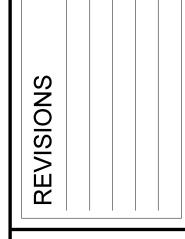

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New (ELA) Depa

VD VOLUME DAMPER

W WATTS

WB WET BULB

VTW VENT THROUGH WALL

WCC WATER COOLED CHILLER

VRV VARIABLE REFRIGERANT VOLUME

R/A RETURN AIR

RLA RATED LOAD AMPS

RTU ROOFTOP UNIT

S/A SUPPLY AIR

SEN SENSIBLE

TOT TOTAL

V VOLTS

RPM REVOLUTIONS PER MINUTE

VAV VARIABLE AIR VOLUME

MOCP MAXIMUM OVERCURRENT PROTECTION REF REFRIGERANT

RE

|Scale Note: Scale |shown on sheets are | accurate for 24x36 prints. Scale is halved for 18x24 prints.

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ΖШО

Sheet No.

FPI FINS PER INCH

FT FEET

FPM FEET PER MINUTE

GPM GALLONS PER MINUTE

HHWR HOT WATER RETURN

HHWS HOT WATER SUPPLY

LAT LEAVING AIR TEMPERATURE

HC HEATING COIL

KW KILOWATT

FSD COMBINATION FIRE SMOKE DAMPER

LPC LOW PRESSURE CONDENSATE

LWB LEAVING WET BULB TEMPERATURE

LWT LEAVING WATER TEMPERATURE

MCA MINIMUM CIRCUIT AMPACITY

LPS LOW PRESSURE STEAM

MAV MANUAL AIR VENT

MFG MANUFACTURER

MHP MOTOR HORSEPOWER

MAX MAXIMUM

MBH 1000 BTUH

MIN MINIMUM

MUA MAKE-UP AIR UNIT

NC NORMALLY CLOSED

NIC NOT IN CONTRACT

NO NORMALLY OPEN O/A OUTSIDE AIR

QTY QUANTITY

OBD OPPOSED BLADE DAMPER

PAHU PACKAGE AIR HANDLING UNIT

EWC ELECTRIC WATER COOLER

FA FREE AREA (SQUARE FEET)

FC FLEXIBLE CONNECTION

EXH EXHAUST

FCU FAN COIL UNIT

FD FIRE DAMPER

FLT FILTER

FLA FULL LOAD AMPS

FPB FAN POWER BOX

EWT ENTERING WATER TEMPERATURE

VIBRATION ISOLATION. FLEXIBLE CONNECTIONS SHALL BE PROVIDED AS CLOSE TO THE EQUIPMENT AS POSSIBLE OR AS

BTU BRITISH THERMAL UNIT

CAV CONSTANT AIR VOLUME

CAP CAPACITY

CLG CEILING

CC COOLING COIL

CD CONDENSATE DRAIN

BTUH BRITISH THERMAL UNIT/HOUR

CDWS CONDENSER WATER SUPPLY

CDWR CONDENSER WATER RETURN

CFM CUBIC FEET PER MINUTE

CONC CONCRETE

dB DECIBEL

DB DRY BULB

DG DOOR GRILLE

CONT CONTINUATION

CV CONSTANT VOLUME

CWR CHILLED WATER RETURN

CWS CHILLED WATER SUPPLY

COP COEFFICIENT OF PERFORMANCE

CRAH COMPUTER ROOM AIR HANDLER

DN DOWN

DWG DRAWING

E/A EXHAUST AIR

EF EXHAUST FAN

ELEC ELECTRICAL

EA EACH

DP PRESSURE DROP

DX DIRECT EXPANSION

EAT ENTERING AIR TEMPERATURE

ESP EXTERNAL STATIC PRESSURE

INDICATED ON THE DRAWINGS

ABBREVIATIONS

ABV ABOVE

AAV AUTOMATIC AIR VENT

ACC AIR COOLED CHILLER

AFF ABOVE FINISHED ROOF

AFR ABOVE FINISHED ROOF


AHU AIR HANDLING UNIT

ARCH ARCHITECTURAL

BDD BACKDRAFT DAMPER

BHP BRAKE HORSEPOWER

amps

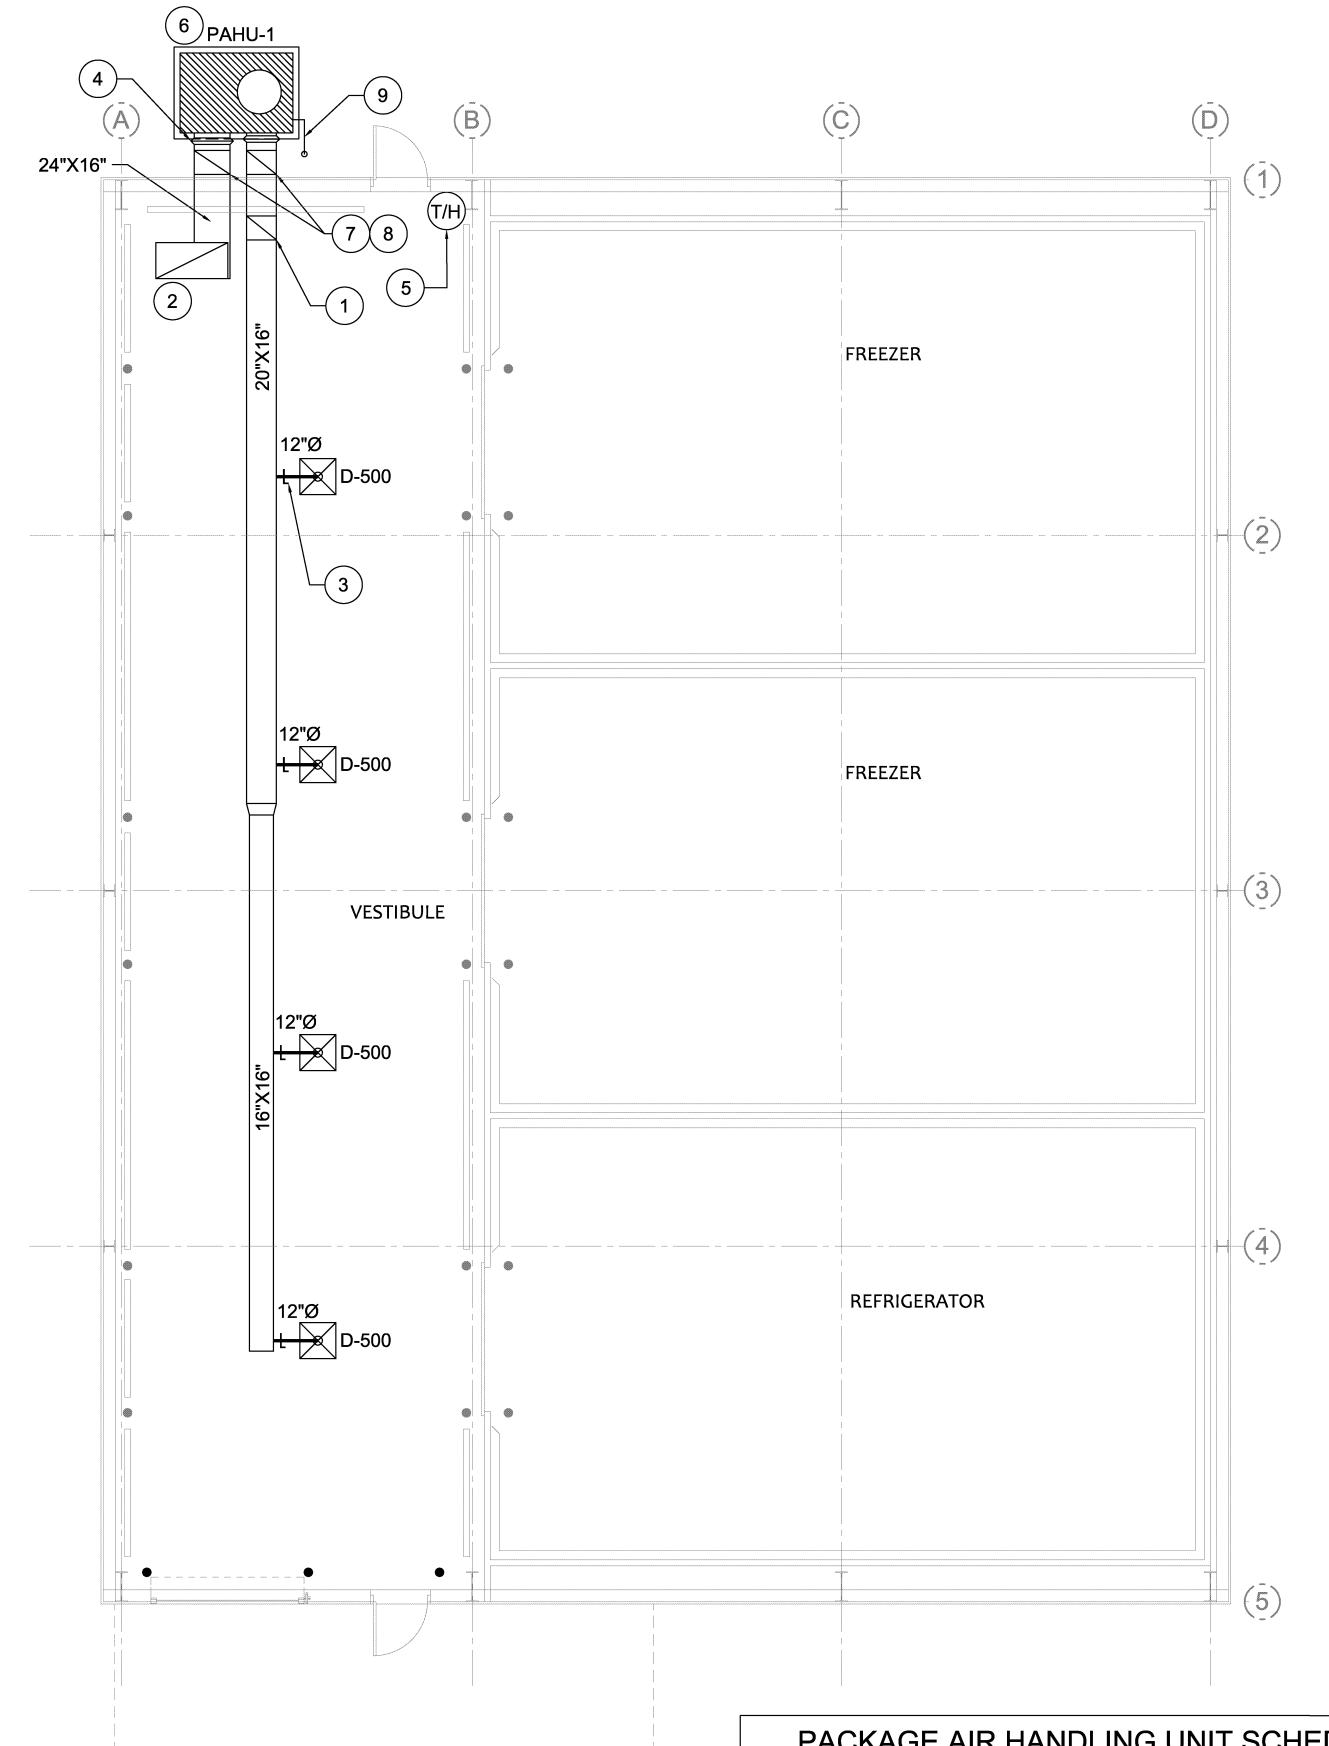



MECHANICAL NOTES

- 1 TURNING VANES IN SUPPLY, RETURN AND EXHAUST DUCT ELBOWS 45 DEGREES OR GREATER, TYPICAL.
- 2 48"X24" RETURN AIR GRILLE, TYPICAL. 1/2"X1/2"X1" ALUMINUM EGGCRATE GRILLE, WHITE.
- 3 LOW LOSS TAP AND MANUAL VOLUME DAMPER WITH STAND OFF BRACKET AND LOCKING QUADRANT, TYPICAL FOR ALL ROUND DUCT TAKE-OFF. SEE AIR EXTRACTOR DETAIL.
- FLEX. CONNECTION TYPICAL ON INLET AND DISCHARGE OF UNIT. CONTRACTOR SHALL MAKE NECESSARY TRANSITIONS FROM INLET AND DISCHARGE OF UNIT TO SUPPLY AND RETURN DUCTWORK.
- THERMOSTAT/ HUMIDISTAT, MOUNTED SAME HEIGHT AS LIGHT SWITCHES. COORDINATE EXACT LOCATION WITH ARCHITECT PRIOR TO ORDERING.
- 6 NEW SLAB MOUNTED PACKAGE AIR HANDLING UNIT. LOCATE UNIT WITH THE NECESSARY OPERATIONAL CLEARANCE FROM ANY BUILDING OVERHANG.
- CONTRACTOR SHALL ROUTE SUPPLY AND RETURN AIR DOCUMENTS.

 BUILDING ABOVE CLOUDS AND SHALL MAKE PENETRATIONS WEATHERTIGHT. CONTRACTOR SHALL ROUTE SUPPLY AND RETURN AIR DUCTWORK UP AND PENETRATE CONTRACTOR SHALL INSTALL DUCT TO SLOPE AWAY FROM EXTERIOR WALL SO THAT POOLING OF WATER BETWEEN DUCT AND WALL WILL NOT OCCUR.
- 8 ALL EXTERIOR DUCTWORK SHALL BE INSULATED DOUBLE WALL DUCTWORK. ALL SEAMS AND BUILDING PENETRATIONS SHALL BE SEALED WEATHERTIGHT. DUCT SHALL BE SLOPED SO THAT NO POOLING OF WATER WILL OCCUR. DUCT SHALL RUN THROUGH EXTERIOR WALL. CONTRACTOR MAY TRANSITION TO SINGLE WALL DUCT ONCE INSIDE BUILDING. SUPPLY AND RETURN AIR DUCTWORK INCLUSIVE.
- 9 ROUTE 1" CONDENSATE DRAIN TO HUBB DRAIN, RE: SHEET P-1.1. CONDENSATE LINE SHALL BE COPPER WITH 3/4" ARMAFLEX INSULATION W/ ALUMINUM JACKET.

MECHANICAL LEGE	END	
SYMBOL	ABBREV	DECRYPTION
	AFF	ABOVE FINISHED FLOOR
	KW	KILOWATTS
	NTS	NOT TO SCALE
	PAHU	PACKAGE AIR HANDLING UNIT
	CFM	CUBIC FEET PER MINUTE
	R/A	RETURN AIR
	S/A	SUPPLY AIR
	2-B-250	DIFFUSER IDENTIFICATION, QUANTITY-NECK SIZE-CFM
	SCH.	SCHEDULE
1)	-	MECHANICAL PLAN NOTE
	-	48"X24" R/A GRILLE
<u> </u>	OBD	OPPOSED BLADE DAMPER
\boxtimes	-	SQUARE LOUVERED CEILING DIFFUSER
(T/H)	-	THERMOSTAT/HUMIDISTAT

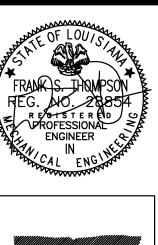

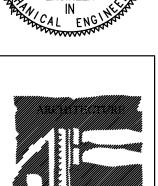

REVISIONS


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Sheet No._

PACKAGE AIR HANDLING UNIT SCHEDULE


- 1. UNIT SHALL BE SINGLE POINT ELECTRICAL SERVICE AS SCHEDULED UNDER A/C UNIT ELECT. SERVICE AND A/C UNIT FLA.
- 2. PROVIDE FACTORY INSTALLED COIL GUARDS.
- 3. PROVIDE MOTORIZED DAMPER AND MANUAL VOLUME DAMPER (INTEGRAL TO UNIT) ON OUTSIDE AIR OPENING.
 4. CONTRACTOR SHALL VERIFY EXACT ELECTRICAL REQUIREMENTS W/ EQUIP. MANUFAC. PRIOR TO ORDERING OR INSTALLING. CONTRACTOR SHALL FULLY COORDINATE W/ ELECTRICAL & PLUMBING PRIOR TO ORDERING & INSTALLING.
- 5. UNIT SHALL HAVE INTEGRAL VIBRATION ISOLATION.
- 6. UNIT MUST HAVE INVERTER COMPRESSOR. 7. UNIT MUST HAVE DEHUMIDIFICATION CAPABILITIES, MODULATING HOT GAS REHEAT.
- 8. MINIMUM OF 12.7 EER / 16.5 SEER.

_																	
GENERA																	
NO.	TONS	TOTAL CFM	CFM F.A.	MIN EXT. S.P.	HP.	FLA.	NO. COMP.	RLA (EA.)	NO. FANS	NO. CIRC.	KW	TOTAL BTUH	MIN. NO. ROWS	ELECT. SERVICE	MIN. CIRC. AMPS	MAX. FUSE SIZE	REMARKS
PAHU-1	5.0	2,000	200	.83"	4.0	4.0	2	6.75	1	4	18	60,000	2	480/3/60	32.1	35	DAIKIN DPS005A OR VALENT, AAON APPROVED EQUAL

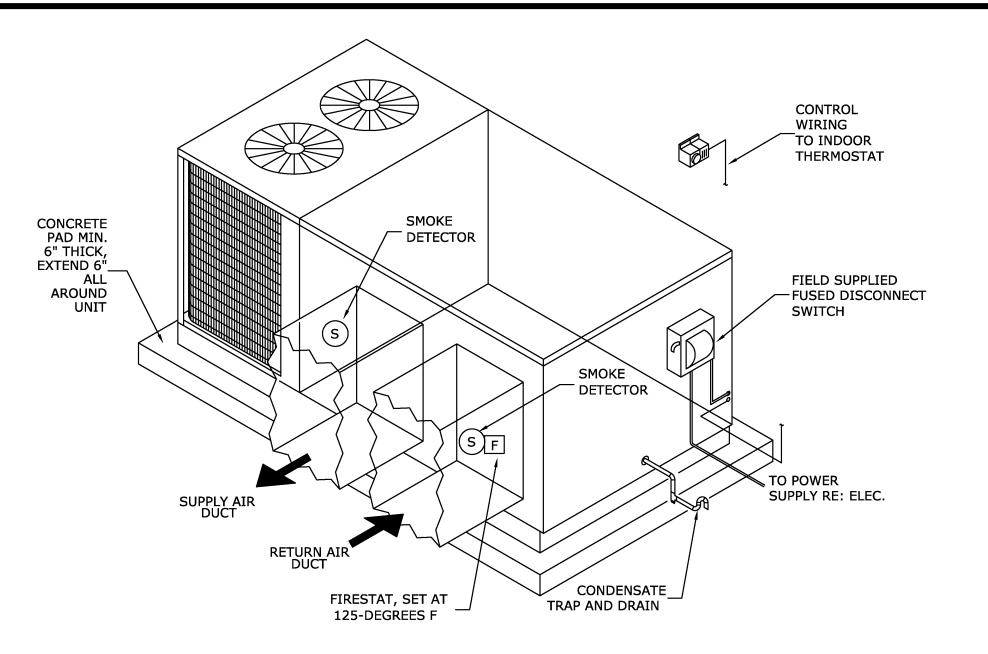

1 1/2" FLANGE — — OUTLET **FLANGE** S/A, R/A, OR E/A **MECHANICAL** DUCT **EQUIPMENT** CANVAS OR OTHER FLANGED APPROVED FLEXIBLE CONNECTION ON MECHANICAL **EQUIPMENT**

MAXIMUM SPACING 1'X18" GAGE STRIF -1/2"X1-1/2"X1/8" 36" 1/4" ROUND ROD 2"X2"X1/8" 1/4" ROUND ROD 2"X2"X1/8" 2"X2"X1/8" 5/16" ROUND ROD 8'-0" 2"X2"X1/8" 3/8" ROUND ROD

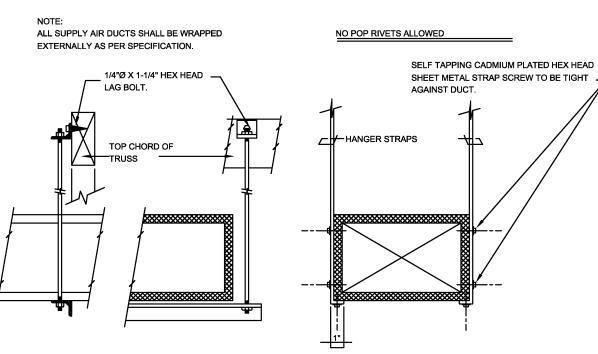


NEAREST VENT (PROVIDE CONTRACTOR TRAP). SHALL INSTALL AS TO PREVENT TRIPPING HAZARD. 4" CONC. PAD CLEAN OUTigspace 4" deep stainless steel auxiliary DRAIN PAN WITH 1" AUXILIARY DRAIN AND FLOAT SWITCH. CONTRACTOR TO PROVIDE AND INSTALL FLOAT SWITCH/WIRING ON ALL DRAIN PANS AND SHALL COORDINATE WITH ELECTRICAL PRIOR TO ORDERING.

CONDENSATE PIPING TO

FLOOR OR HUB DRAIN, OR

DETAIL-CONDENSATE DRAIN SCALE: N.T.S.

DETAIL-SLAB MOUNTED PACKAGE AIR HANDLING UNIT SCALE: N.T.S.

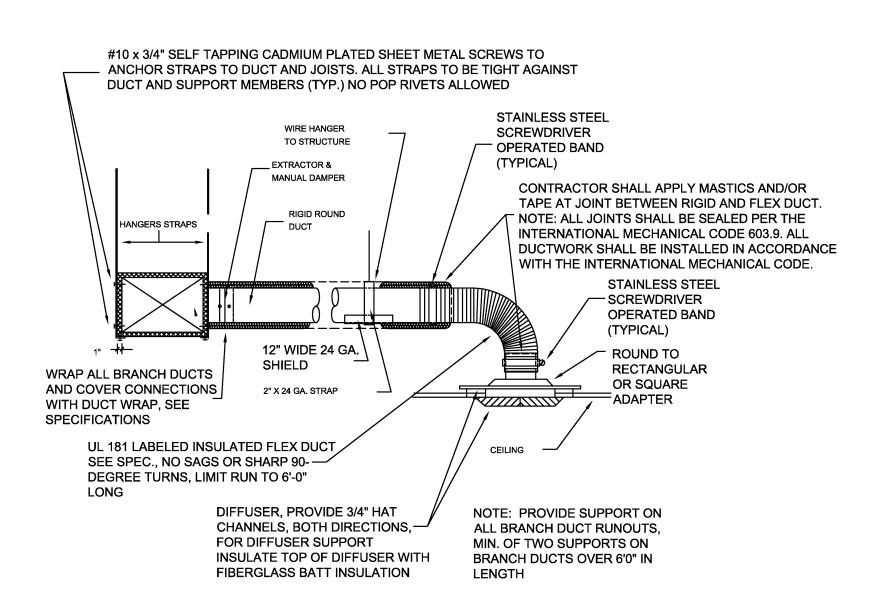

DETAIL-FLEXIBLE CONNECTION SCALE: N.T.S

DETAIL- DUCTWORK SUPPORTS SCALE: NO SCALE

FROM WALL.

SQUARE 90° ELBOW SQUARE 45° ELBOW

DETAIL-DUCT LAYOUT

TURNING VANE DETAIL

AIR FLOW

ROUND DUCT, SEE ROD CONTINUOUS ON 2" W.G. CLASS ____ PLANS FOR SIZE AND ON ALL DAMPERS OVER 12" DIA.

DETAIL-ROUND MANUAL VOLUME DAMPER SCALE: N.T.S.

THE WALL CONSTRUCTION.

DUCT SIZE	ANGLE
18"X12"	1-1/2"X16 GA.
24"X20"	1"X1/8"
DUCT GAUGE	ALLOWABLE LOAD PER FASTENE
28, 26	25 LB.
24, 22, 20	35 LB.
18, 16	50 LB.
*WELD BOLT	OR NO 8 SCREW (MIN) DEVIATION

1. BRACKETS ARE SIZED FOR 12 FEET OF DUCT, MAXIMUM.

2. LOCATE DUCTS AGAINST WALL OR MAXIMUM OF 2" AWAY

A. TENSILE LOAD = 3/8 X DUCT WEIGHT; SAFETY FACTOR 4.

B. SHEAR LOAD X 1/2 X DUCT WEIGHT: SAFETY FACTOR 4.

MODIFICATIONS TO ENSURE PROPER SUPPORT BASED ON


3. EACH WALL ANCHOR SHALL SATISFY THE FOLLOWING

4. CONTRACTOR SHALL VERIFY WALL CONSTRUCTION

PRIOR TO INSTALLATION AND MAKE ALL NECESSARY


CRITERIA UNLESS OTHER ANALYSIS IS MADE:

WELD, BOLT OR NO.8 SCREW (MIN.) DEVIATION PERMITTED BY OTHER ANALYSIS. X=1", Y=2"; ADD OTHERS TO ACCOMMODATE LOAD. MINIMUM OF 3 ON 24" WIDTH AND UP. ADD ALONG SIDES NEAREST

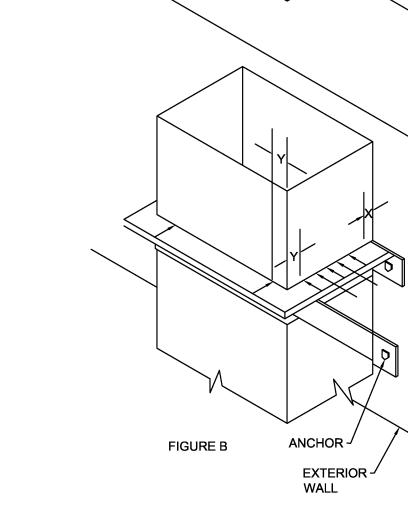

FASTENER

EXTERIOR

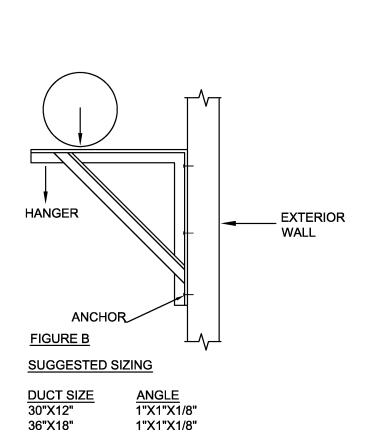


1-1/4"X1-1/4"X1/8"

1-1/4"X1-1/4"X1/8"

DETAIL-DUCTWORK SUPPORTS FROM EXTERIOR WALL SCALE: N.T.S.

DETAIL-DIFFUSER CONNECTION SCALE: N.T.S.

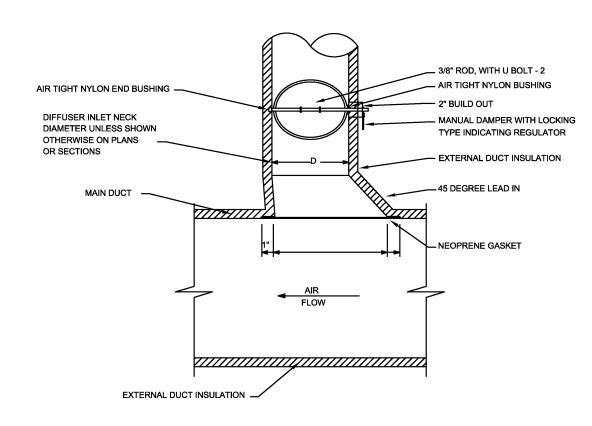

1. THIS DETAIL FOR EXTERNALLY INSULATED DUCTWORK. 2. EXTEND ROUND SHEETMETAL DUCTWORK AND ASSOCIATED DUCT INSULATION FROM MAIN DUCT, SO FLEXIBLE DUCT LENGTH DOES NOT EXCEED 6 FEET. 3. FLEX DUCT: FLEXMASTER TYPE 8M-R6, OR APPROVED EQUAL - SUBMIT SAMPLE

FOR APPROVED EQUAL.

SCALE: N.T.S.

DETAIL-EXTRACTOR & MANUAL DAMPER

EXTRACTOR, ADJUSTABLE NECK DIAMETER, SEE PLANS FOR SIZE SQUARE — DIFFUSER

SAME DEPTH OF DUCT,

(DEPTH VARIES, FIELD

WHERE POSSIBLE

VERIFY)

DETAIL-DIFFUSER DROP INSTALLATION

42"X24"

48"X30"

 $\propto \Xi$


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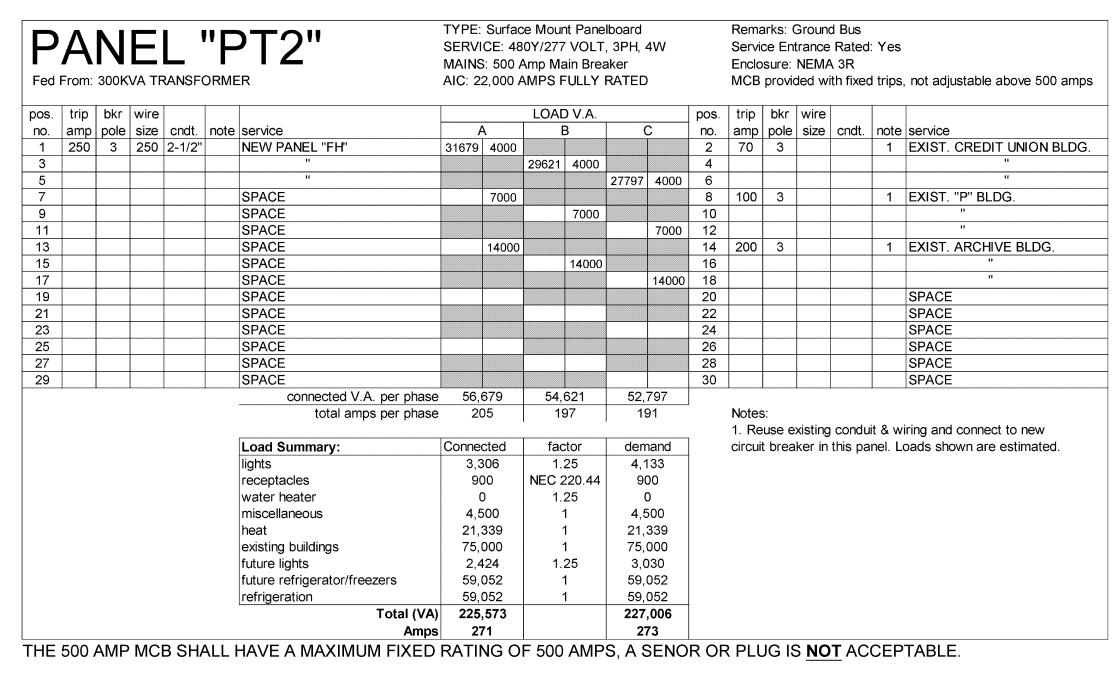
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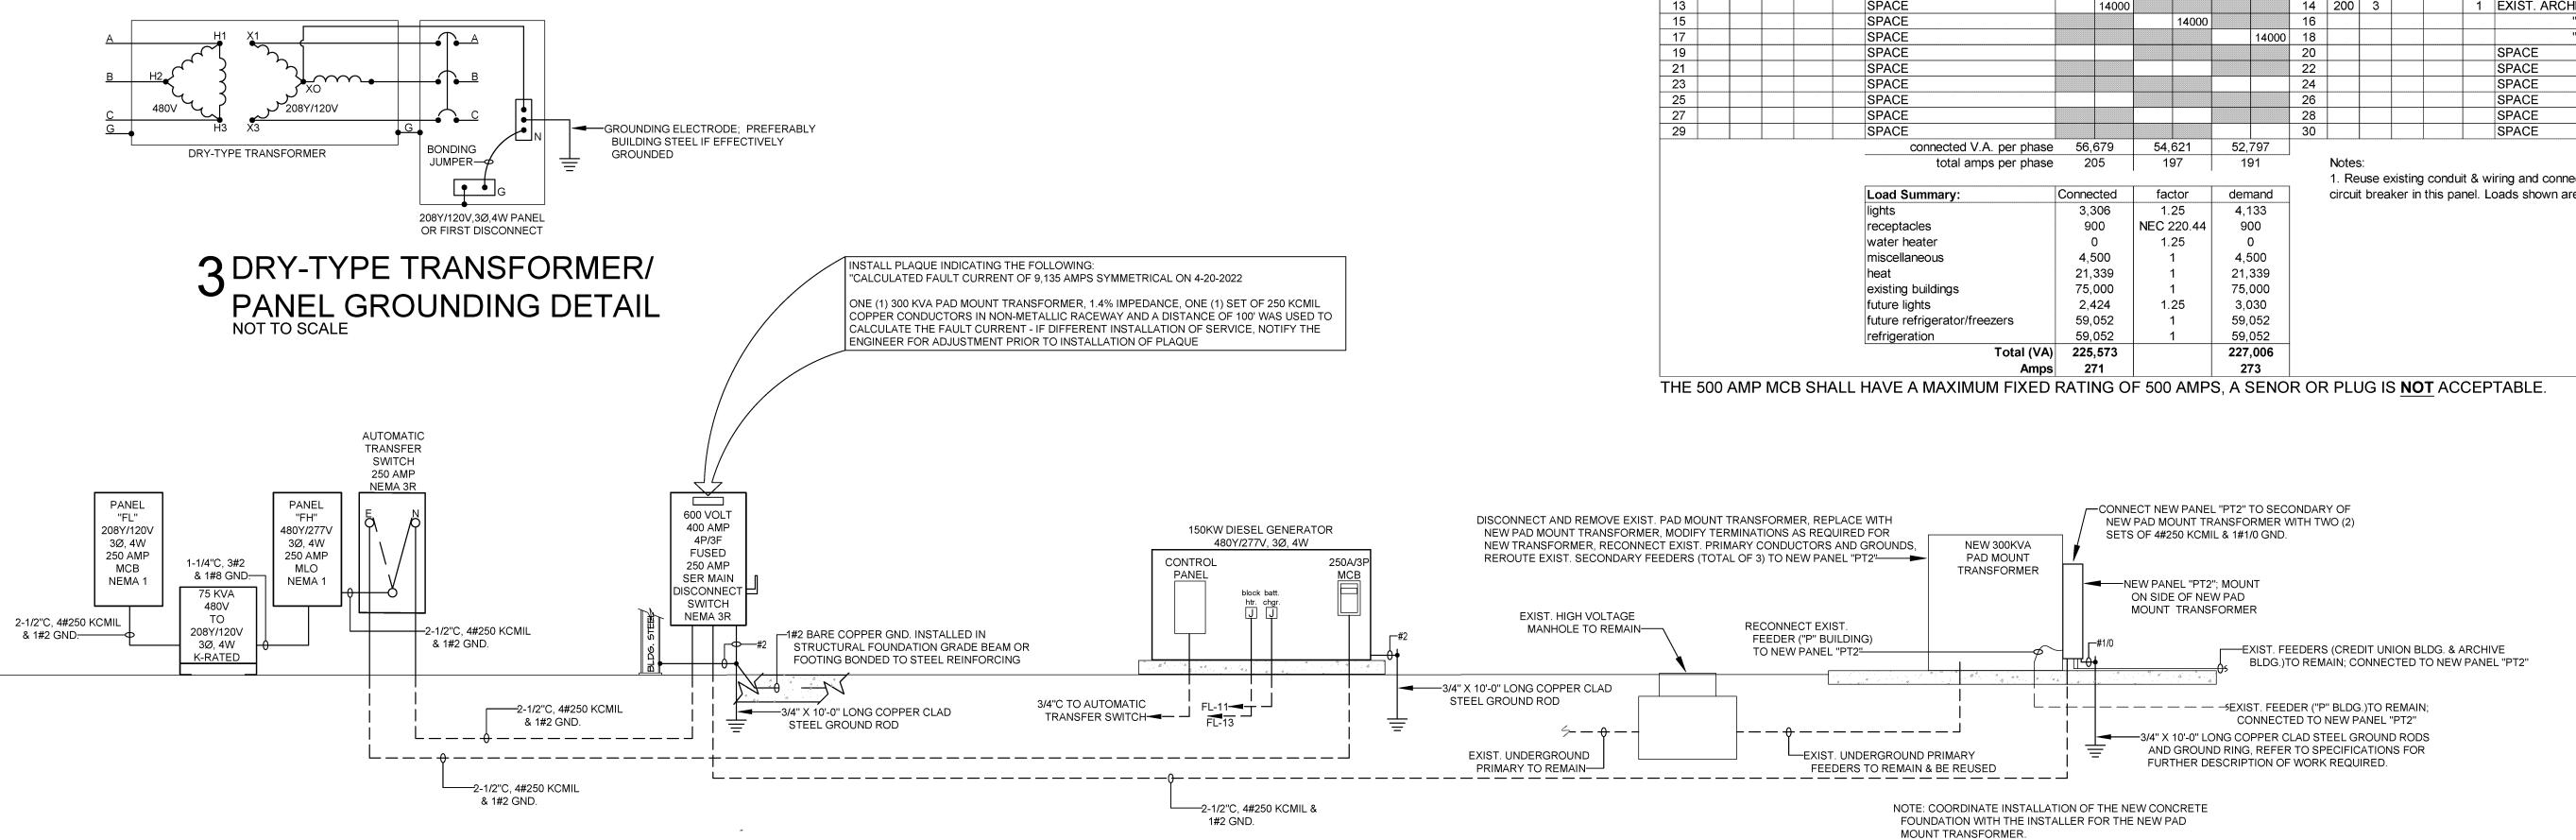
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New ELA Depa







SYMBOL SCHEDULE

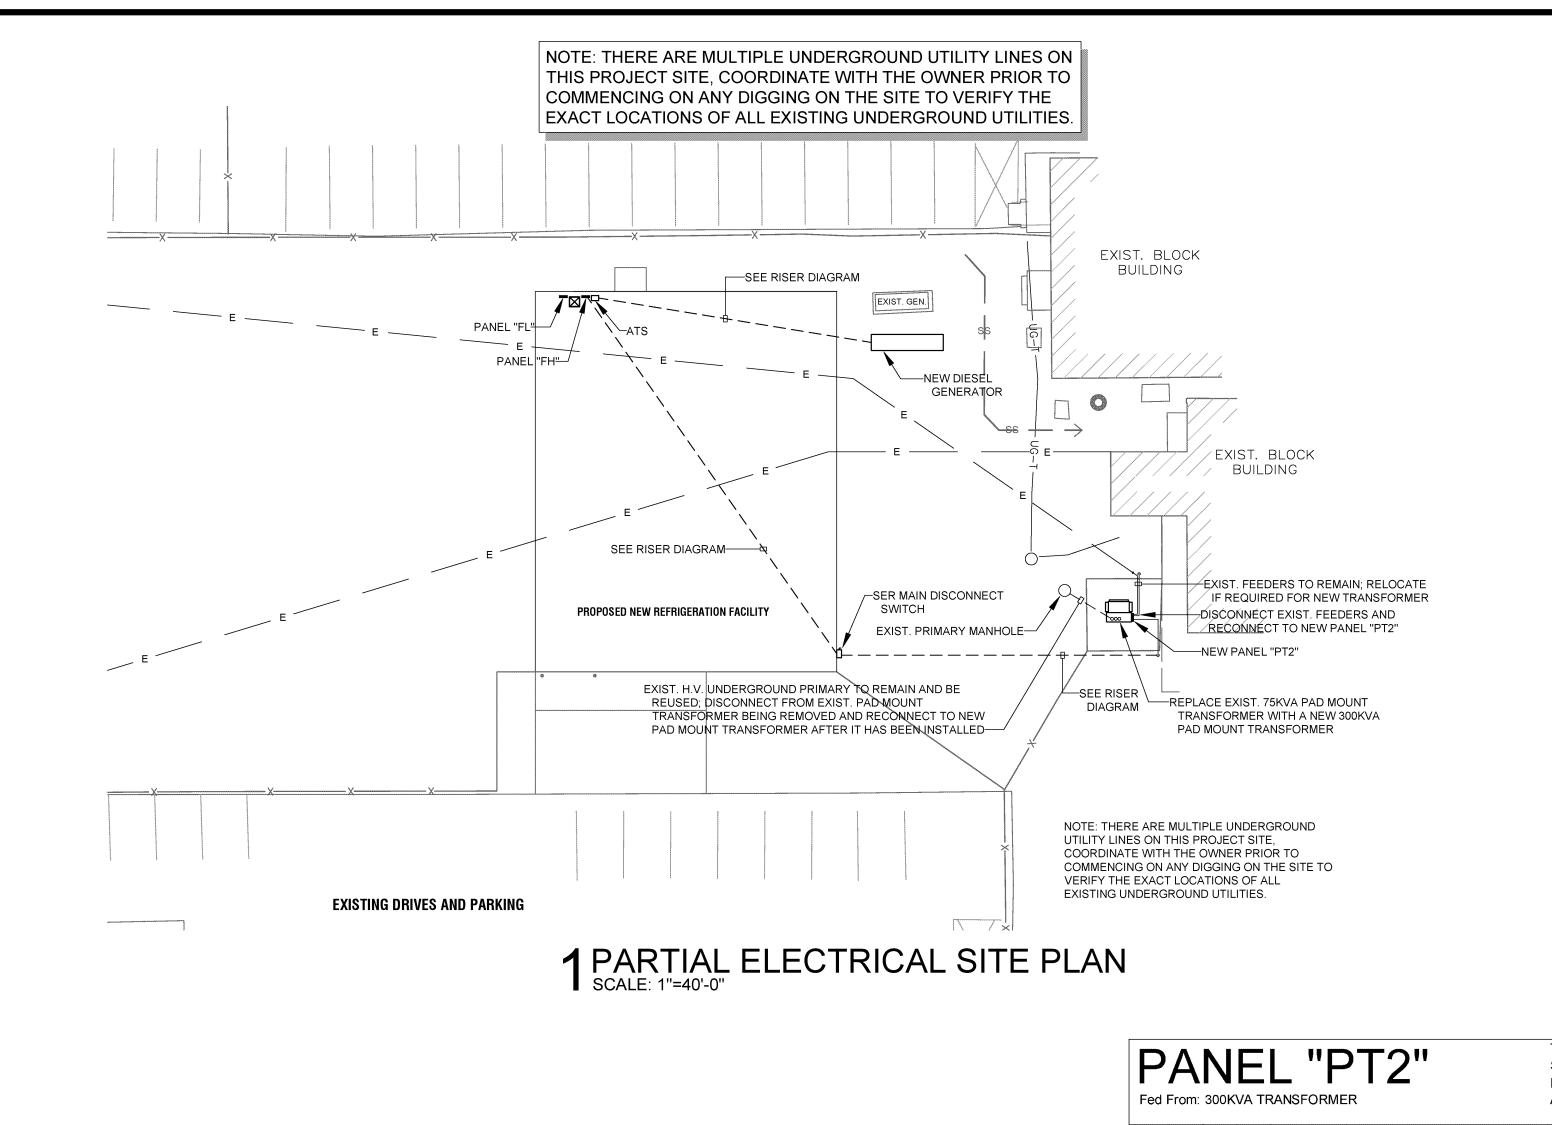GROUND FAULT INTERRUPTER DUPLEX RECEPTACLE

CONDUIT BELOW SLAB; DASHES DENOTE NO. OF WIRES

HOMERUN; DASHES DENOTE NO. OF WIRES

FUSED SAFETY DISCONNECT SWITCH

CONDUIT IN WALL OR CEILING; DASHES DENOTE NO. OF WIRES

DAVID J. SOILEAU

License No. 32356

PROFESSIONAL ENGINEER

IN

4/25/2022

ARCHITECTURE

CRESS ARCHIT

REVISION

Scale Note: Scale

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prints. Scale is halved

for 18x24 prints.

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TION/

LED FIXTURE; "A" DENOTES TYPE

PHOTOELECTRIC CELL

3-WAY TOGGLE SWITCH

DUPLEX RECEPTACLE

POWER PANEL

JUNCTION BOX WEATHERPROOF

KEYNOTE

ABOVE FINISHED FLOOR

SINGLE POLE TOGGLE SWITCH

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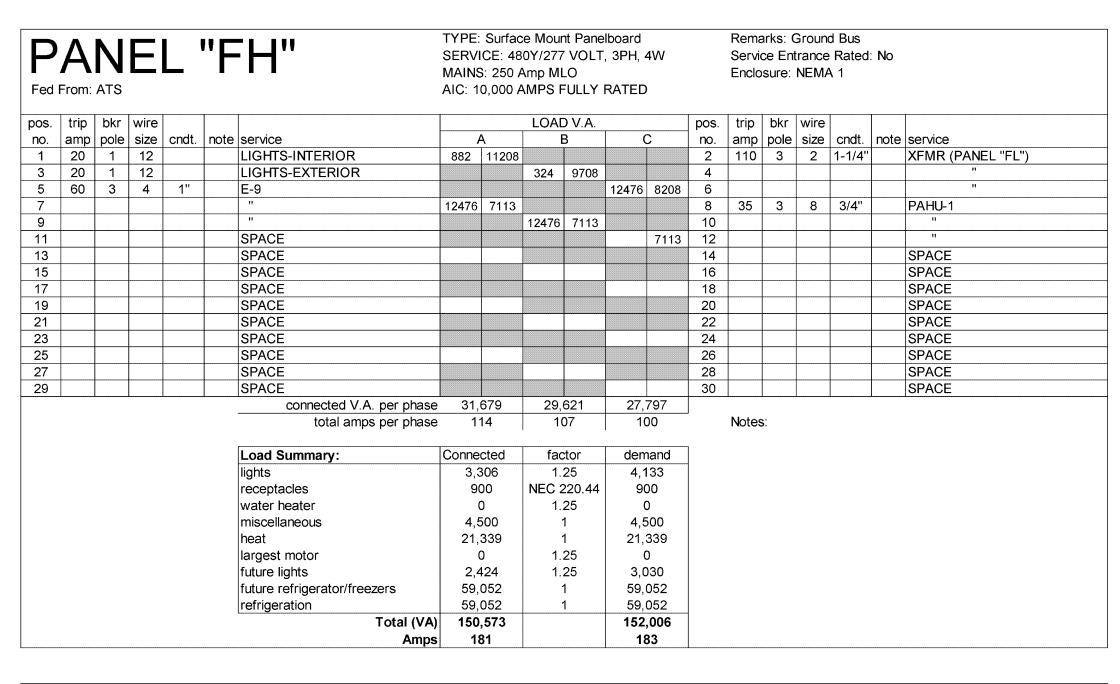
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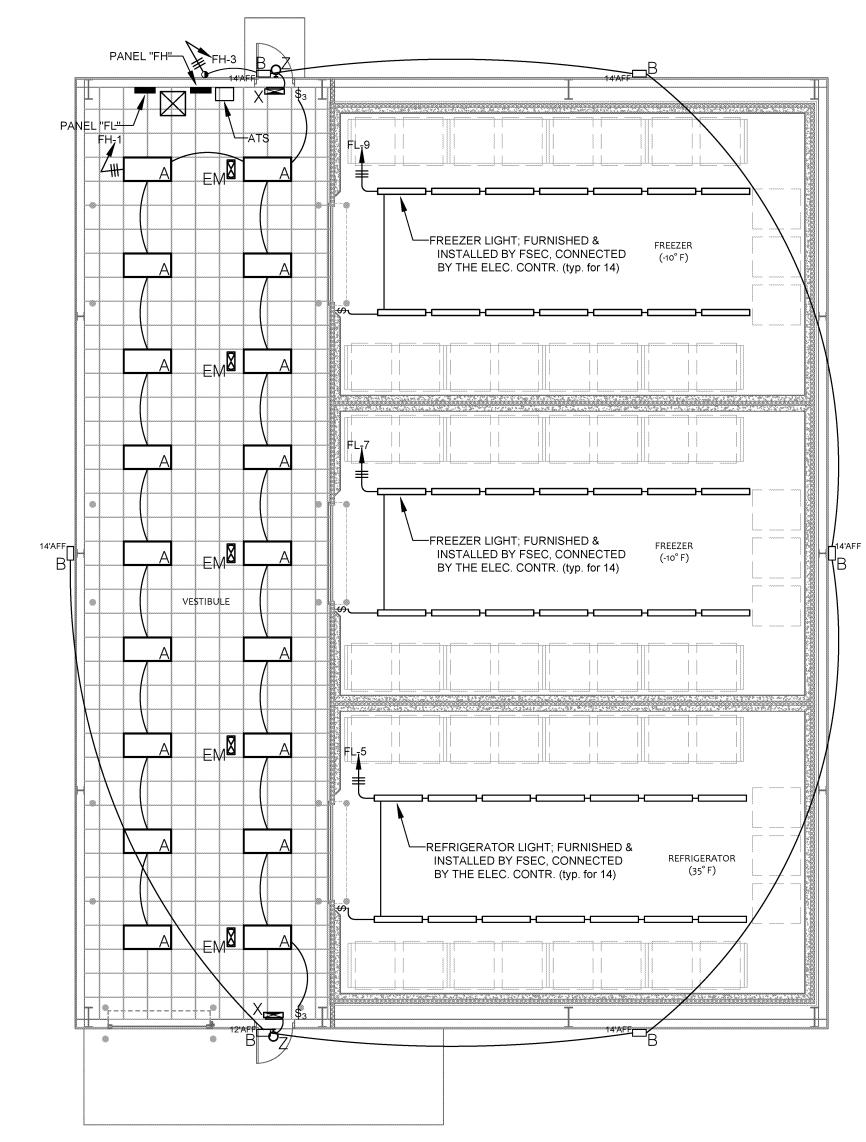
CEILING MOUNT EMERGENCY LIGHTING UNIT

Sheet No._

2RISER DIAGRAM
SCALE: NONE



				L ⊣'' via X		- L"	SERVI MAINS	Surfac ICE: 20 S: 250 A 0,000 A	8Y/120 Amp Ma	VOLT ain Brea	, 3PH, aker			Servi	ce En	Ground trance NEMA	Rated	: Yes	
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7	20	1	12	1	 	LIGHTS-FREEZER	700	1200			700	1200	8	20	1	12			E-5
9	20	1	12			LIGHTS-FREEZER	700	1200	700	240			10	20	1	12		1	E-7
11	20	1	12			GENERATOR BATTERY CHGR.			700	240	240	240	12	20	1	12			E-7
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						Total (VA)	1	588				638							
						Amps	1:	38			14	41							



1 COLD STORAGE LIGHTING PLAN SCALE: 1/8"=1'-0"

- LIGHTING PLAN NOTES

 1. THE ARCHITECTURAL FEATURES SHOWN ON THESE DRAWINGS UPON WHICH THE CONTRACT DOCUMENTS ARE BASED MAY BE INACCURATE OR INCOMPLETE. THE CONTRACTOR SHALL COORDINATE ALL INSTALLATION REQUIREMENTS WITH THE MOST CURRENT
- 2. THE CONTRACTOR IS RESPONSIBLE FOR INCLUDING IN BID A COMPLETE AND WORKING SYSTEM IN ACCORDANCE WITH THE MOST CURRENT TO DATE SEALED ARCHITECTURAL CONTRACT DOCUMENTS.
- 3. VERIFY THE EXACT LOCATION OF ALL LIGHT FIXTURES WITH THE REFLECTED CEILING PLAN.


TO DATE SEALED ARCHITECTURAL CONTRACT DOCUMENTS AND MODIFY AS REQUIRED.

- 4. ELECTRICAL CONTRACTOR SHALL VERIFY THE TYPE OF CEILINGS TO ACCEPT LIGHT FIXTURES; PROVIDE APPROPRIATE TRIMS AT EACH CEILING TYPE. REFERENCE THE REFLECTED CEILING PLAN FOR CEILING TYPES.
- 5. VERIFY THE EXACT LOCATION OF ALL LIGHT SWITCHES WITH THE ARCHITECT PRIOR TO ROUGH-IN.
- ELECT. CONTR. SHALL VERIFY THE FINISH OF ALL INTERIOR AND EXTERIOR LIGHTS WITH THE ARCHITECT PRIOR TO ORDERING ANY LIGHT FIXTURES.
- CONNECT ALL EXIT SIGNS AND EMERGENCY LIGHTS TO THE LIGHTING CIRCUIT IN THE ROOM THEY ARE LOCATED IN AHEAD OF ALL
- 8. COORDINATE THE EXACT LOCATION OF THE PHOTOCELL WITH THE ARCHITECT PRIOR TO ROUGH-IN.

	FIXTURE SCHEDULE										
		LAMPING									
TYPE	MANUF./CATALOG NO.	TYPE	QNTY	VOTAGE	WATTAGE	FINISH	DESCRIPTION				
Α	LITHONIA #CPX 2X4 AL08 SWW7 M2	4,033-6,563	N/A	120/277	49	WHITE	2' X 4' LAY-IN FLAT PANEL, ACRYLIC LENS, UNIVERSAL VOLTAGE				
		LUMEN/ 4000°K					ELECTRONIC DIMMING DRIVER, LUMEN SWITCHABLE				
В	LITHONIA #TWX2 LED ALO 50K MVOLT PE FINISH	1,450-6,850	N/A	120/277	54	WHITE	LED WALL PACK, UNIVERSAL VOLTAGE ELECTRONIC DRIVER, LUMEN				
		LUMEN/ 5000°K					SWITCHABLE, WET LOCATION LISTED				
X	LITHONIA #EXR LED EL	RED LED	N/A	120/277	6	WHITE	EXIT LIGHT, THERMOPLASTIC HOUSING, BUILT-IN BATTERY				
]									
Z	EXITRONIX #TR-WB-XX(COLOR)	LED	N/A	120/277	6	AS	EXTERIOR EMERGENCY EGRESS LIGHT, DIE-CAST ALUMINUM HOUSING,				
		1				SELECTED	BUILT-IN BATTERY, WET LOCATION LISTED				
EM	LITHONIA #ELM2L	LED	N/A	120/277	6	WHITE	WALL MOUNT EMERGENCY LIGHTING UNIT WITH BUILT-IN BATTERY,				
		1					THERMOPLASTIC HOUSING				

POWER PLAN NOTES

- 1. THE ARCHITECTURAL FEATURES SHOWN ON THESE DRAWINGS UPON WHICH THE CONTRACT DOCUMENTS ARE BASED MAY BE INACCURATE OR INCOMPLETE. THE CONTRACTOR SHALL COORDINATE ALL INSTALLATION REQUIREMENTS WITH THE MOST CURRENT TO DATE SEALED ARCHITECTURAL CONTRACT DOCUMENTS AND MODIFY AS REQUIRED.
- THE CONTRACTOR IS RESPONSIBLE FOR INCLUDING IN BID A COMPLETE AND WORKING SYSTEM IN ACCORDANCE WITH THE MOST CURRENT TO DATE SEALED ARCHITECTURAL CONTRACT DOCUMENTS.
- 3. DEVICE LOCATIONS REPRESENT INTENT AND ARE NOT MEANT TO SHOW THE EXACT LOCATION OF DEVICES. DO NOT SCALE DEVICES FROM THESE DRAWINGS. VERIFY EXACT LOCATION OF ALL DEVICES WITH THE ARCHITECT PRIOR TO ROUGH-IN.
- 4. VERIFY THE EXACT LOCATION, VOLTAGE, PHASE, AMPERAGE, ETC. OF ALL MECHANICAL AND PLUMBING EQUIPMENT WITH THE MECH. CONTR. AND PLUMBING CONTR. PRIOR TO ROUGH-IN.
- 5. EACH 120 VOLT CIRCUIT SHALL HAVE ITS OWN SEPARATE NEUTRAL; SHARING OF NEUTRAL CONDUCTORS IS NOT ALLOWED.
- 6. ALL DEVICES SHALL BE LOCATED 18"AFF UNLESS NOTED OTHERWISE.
- 7. ALL COVER PLATES SHALL MATCH THE WALL AND CEILING COLORS.
- 8. VERIFY THE EXACT LOCATION, VOLTAGE, PHASE, AMPERAGE, ETC. OF ALL REFRIGERATION EQUIPMENT WITH THE REFRIGERATION EQUIPMENT CONTR. PRIOR TO ROUGH-IN.

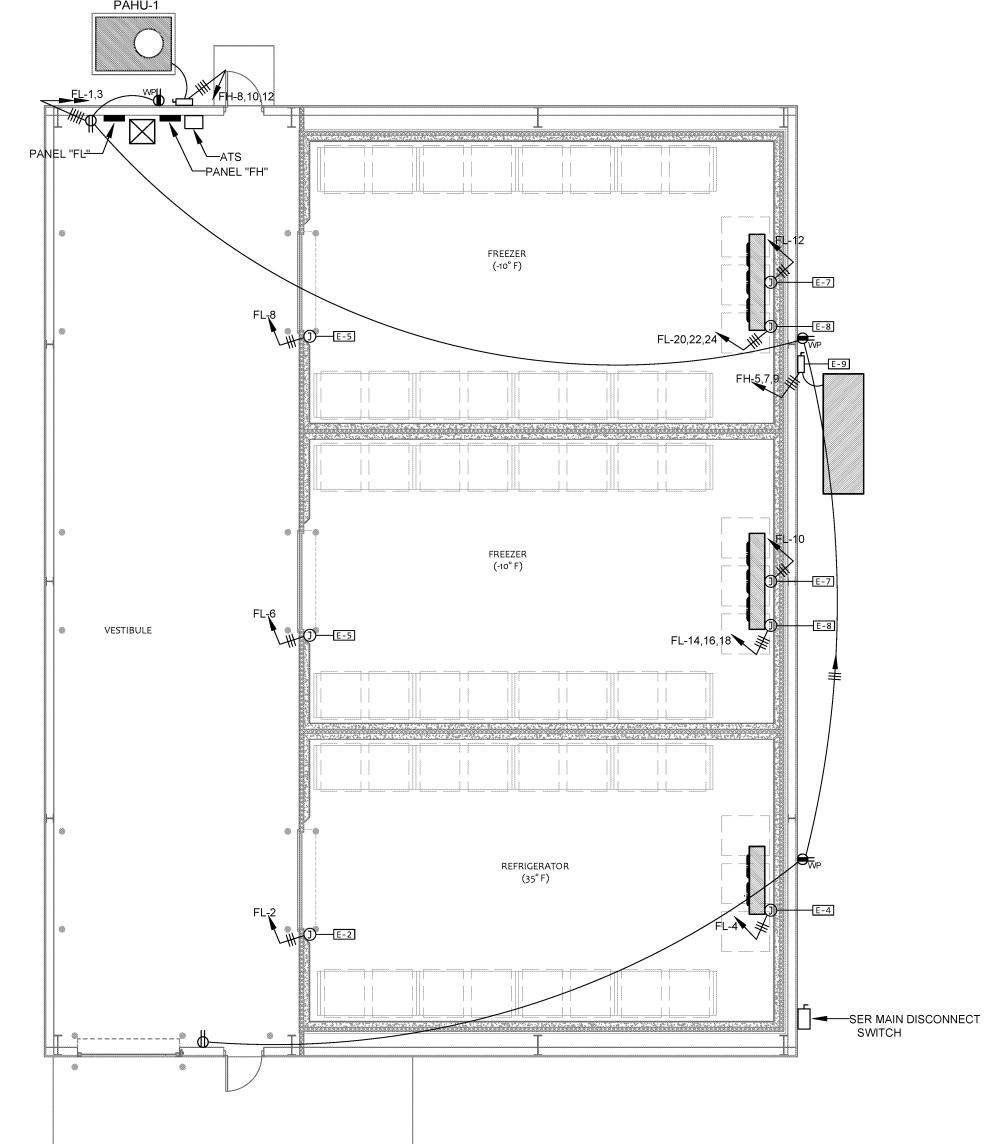

2COLD STORAGE POWER PLAN SCALE: 1/8"=1'-0"

		REFRIGERATION EQUIPMENT ELECTRICAL ROUGH-IN DATA SCHEDULE	
CONN. NO.	ITEM NO.	DESCRIPTION OF UTILITY REQUIREMENTS	NOTES
E-2	1	10A 120V DFA FOR DOOR FRAME HEATER. PRESSURE RELIEF PORT HEATER, AND	
	'	TEMPERATURE ALARM SYSTEM OF WALK-IN COOLER ROOM	6-9
E-4	2	7A 120V 1-PH DFA FOR EVAPORATOR COIL OF WALK-IN COOLER ROOM	6,7,8,10
E-5	1	10A 120V DFA FOR DOOR FRAME HEATER, PRESSURE RELIEF PORT HEATER, AND	
		TEMPERATURE ALARM SYSTEM OF EACH WALK-IN FREEZER ROOM	6-9
E-7	2	2A 120V DFA FOR EACH CONDENSATE DRAIN LINE HEATER OF EACH WALK-IN FREEZER ROOM	6-8
E-8	2	23.2A 208V 3-PH DFA FOR EVAPORATOR COIL OF EACH WALK-IN FREEZER ROOM	6,7,8,10
E-9	2	60A 480V 3-PH CIRCUIT (56.3 MCA) 36" ABOVE CONCRETE PAD FOR WALK-IN COOLER/FREEZER	
		REMOTE CONDENSING UNIT	11

THESE NOTES WERE TAKEN FROM THE REFER TO FOOD SERVICES DRAWINGS, REFER TO FOOD SERVICES DRAWING FOR A FULL DESCRIPTION OF WORK REQUIRED BY THIS CONTRACTOR.

REFRIGERATION EQUIPMENT ELECTRICAL ROUGH-IN DATA SCHEDULE

- 1. ROUGH-IN PLAN SHOWS APPROXIMATE LOCATIONS FOR UTILITY REQUIREMENTS OF FOOD SERVICE EQUIPMENT SPECIFIED. CONTRACTOR SHALL FURNISH DIMENSIONED LOCATIONS FROM FINISHED WALLS AND/OR CENTER-LINE OF COLUMNS FOR ALL UTILITIES SHOWN ON CONTRACT DOCUMENT ROUGH-IN DRAWINGS.
- 2. WHERE POSSIBLE, ALL ELECTRICAL CONDUIT/WIRING SHALL BE EXTENDED UP THROUGH AND OUT OF BUILDING
- 3. EXTEND AND CONNECT WIRING FROM JUNCTION BOXES TO CONNECTION POINTS ON FOOD SERVICE EQUIPMENT DIVISION 26..
- 4. WALL-MOUNTED JUNCTION BOXES SHALL BE RECESSED IN BUILDING WALL SO THAT EQUIPMENT CAN BE INSTALLED AGAINST WALLS.
- FURNISH AND INSTALL ALL NECESSARY LINE DISCONNECT SWITCHES, UNLESS SPECIFIED OTHERWISE DIVISION
- FURNISH AND INSTALL CONDUIT, JUNCTION BOXES, AND FIELD WIRING FOR COILS, CEILING-MOUNTED LIGHT
 FIXTURES, PRESSURE RELIEF PORTS, AND FREEZER DRAIN LINE HEATERS OF WALK-IN COOLERS/AND FREEZERS -
- 7. ELECTRICAL CONDUIT WITHIN WALK-IN SHALL BE FILLED (INSIDE CONDUIT) WITH FOAM URETHANE TO PREVENT CONDENSATION DIVISION 26.
- 8. PENETRATIONS OF WALK-IN CEILING/WALL PANELS SHALL BE SEALED WITH USDA-APPROVED SEALANT.
- 9. FURNISH AND INSTALL 18 GAUGE WIRING AND TEMPERATURE SENSORS OF TEMPERATURE ALARM SYSTEMS IN ACCORDANCE WITH SPECIFICATIONS DIVISION 11. REFER TO TEMPERATURE ALARM SYSTEM WIRING DIAGRAM D11, SHEET FS2.2.
- 10. WALK-IN FREEZER EVAPORATOR COIL SPECIFIED INCLUDES PRE-WIRED ON-DEMAND DEFROST CONTROLLER.
- 11. FURNISH AND INSTALL PRE-WIRED UL-LISTED CIRCUIT BREAKERS AND LINE DISCONNECT SWITCH DIVISION 26.

THESE NOTES WERE TAKEN FROM THE REFER TO FOOD SERVICES DRAWINGS, REFER TO FOOD SERVICES DRAWING FOR A FULL DESCRIPTION OF WORK REQUIRED BY THIS CONTRACTOR.

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PACKAGE AIR HANDLING UNIT SCHEDULE - ELECTRICAL LOAD DATA GENERAL SUPPLY FAN COMPRESSORS COND. FAN ELECTRIC HEAT ELECTRICAL (UNIT) NO. TONS CFM F.A. HP. FLA. NO. RLA COMP. (EA.) FANS CIRC. KW SERVICE AMPS SIZE

6.75

18 480/3/60 32.1



DAVID J. SOILEAU
License No. 32356
PROFESSIONAL SINCE
IN
ENGINEER
IN
4/25/2022

PROFESSIONAL SERVICE IN ENGINEER IN LEGISLE ARCHITECTURE

LLC.

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25) 930-6045

CRESS & LOPREST
ARCHITECTS L.L

A PROFESSIONAL ARCHITECTURAL COMF
10606 COURSEY BLVD., STE. A
BATON ROUGE, LOUISIANA 70

REVISIONS

Scale Note: Scale shown on sheets are accurate for 24x36 prints. Scale is halved for 18x24 prints

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Date: 6-15-22

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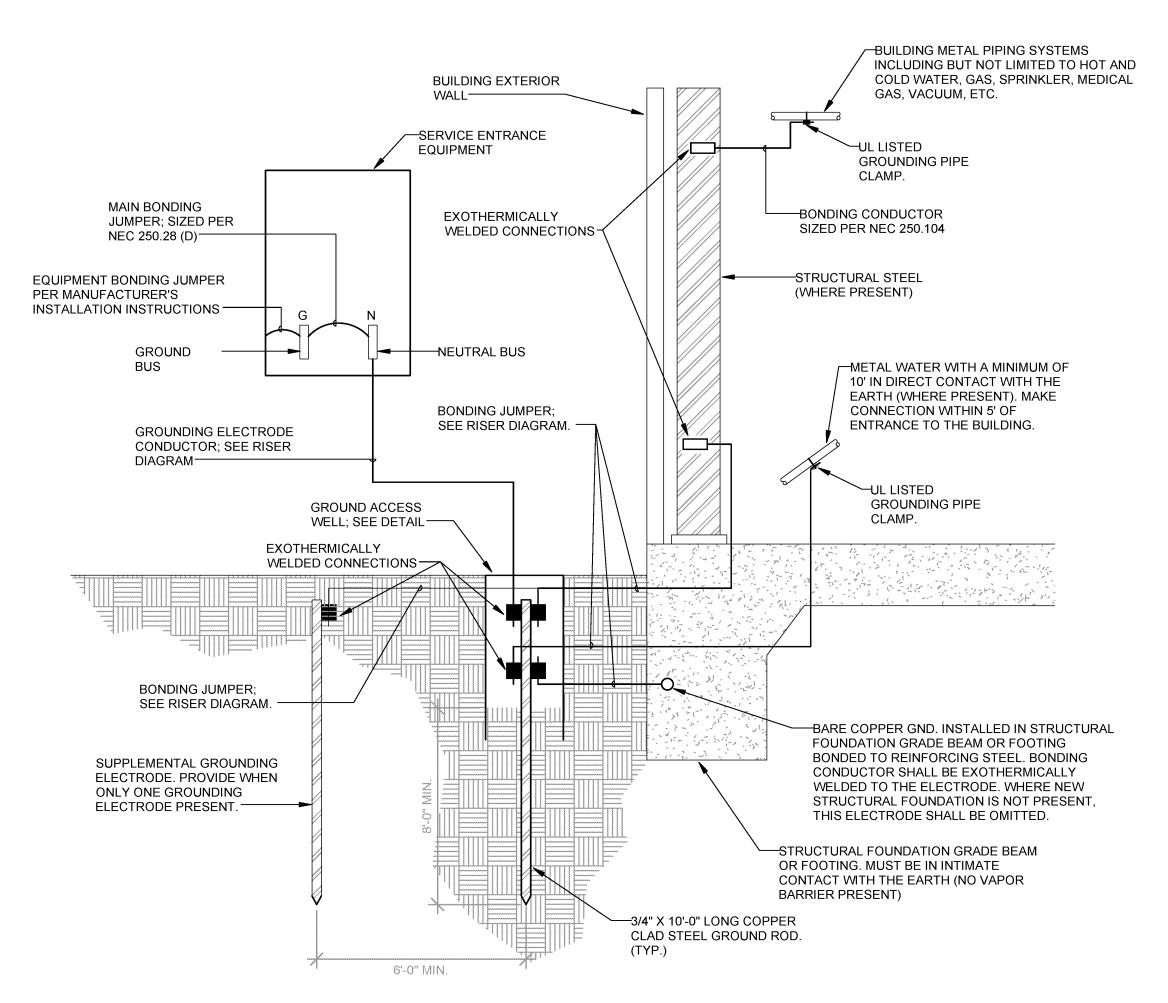
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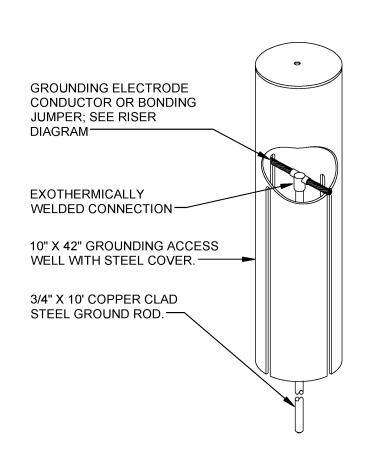
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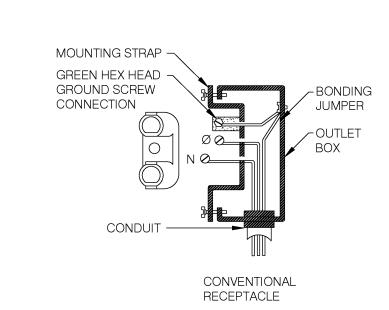
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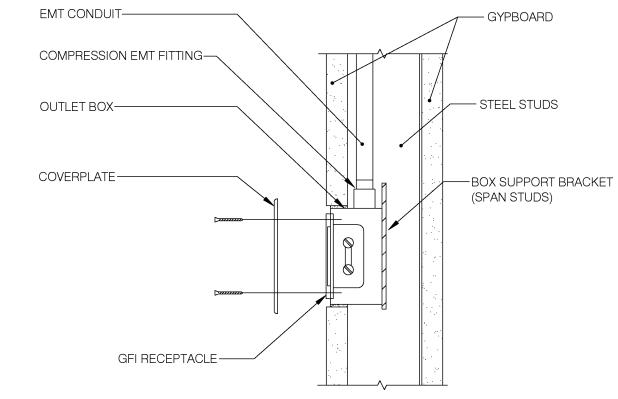
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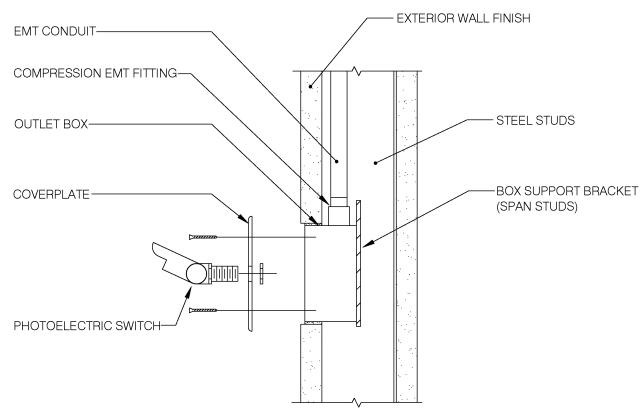
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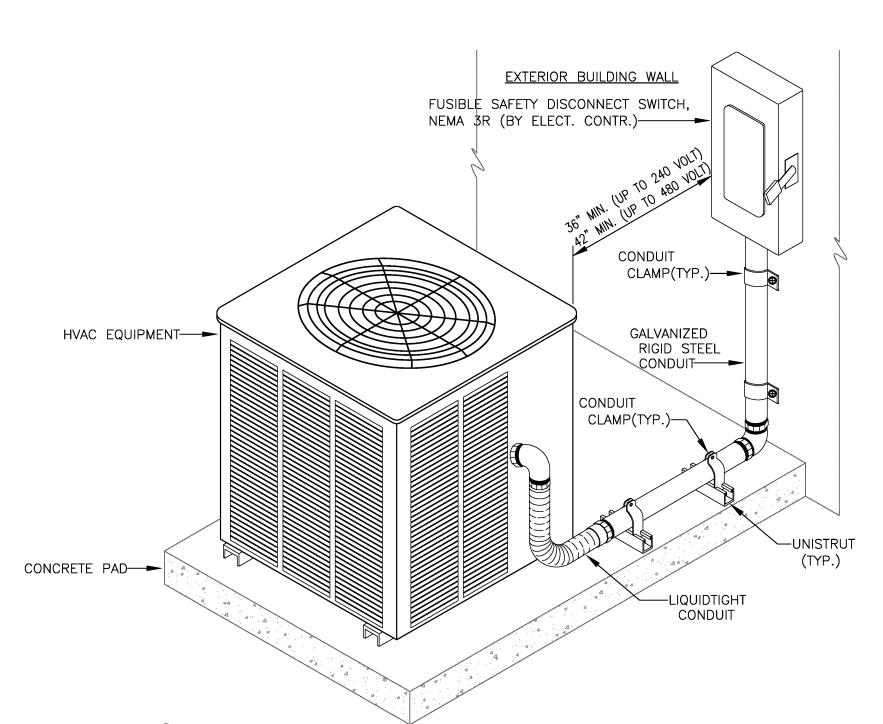
3-RECEPTACLE INSTALLATION DETAIL SCALE: NOT TO SCALE



4-FLUSH MOUNT OUTLET MOUNTING DETAIL SCALE: NOT TO SCALE



5 - FLUSH MOUNT PHOTOELECTRIC SWITCH MOUNTING DETAIL



6 - REFRIGERATION EQUIPMENT DISCONNECT SWITCH CLEARANCE DETAIL SCALE: NOT TO SCALE






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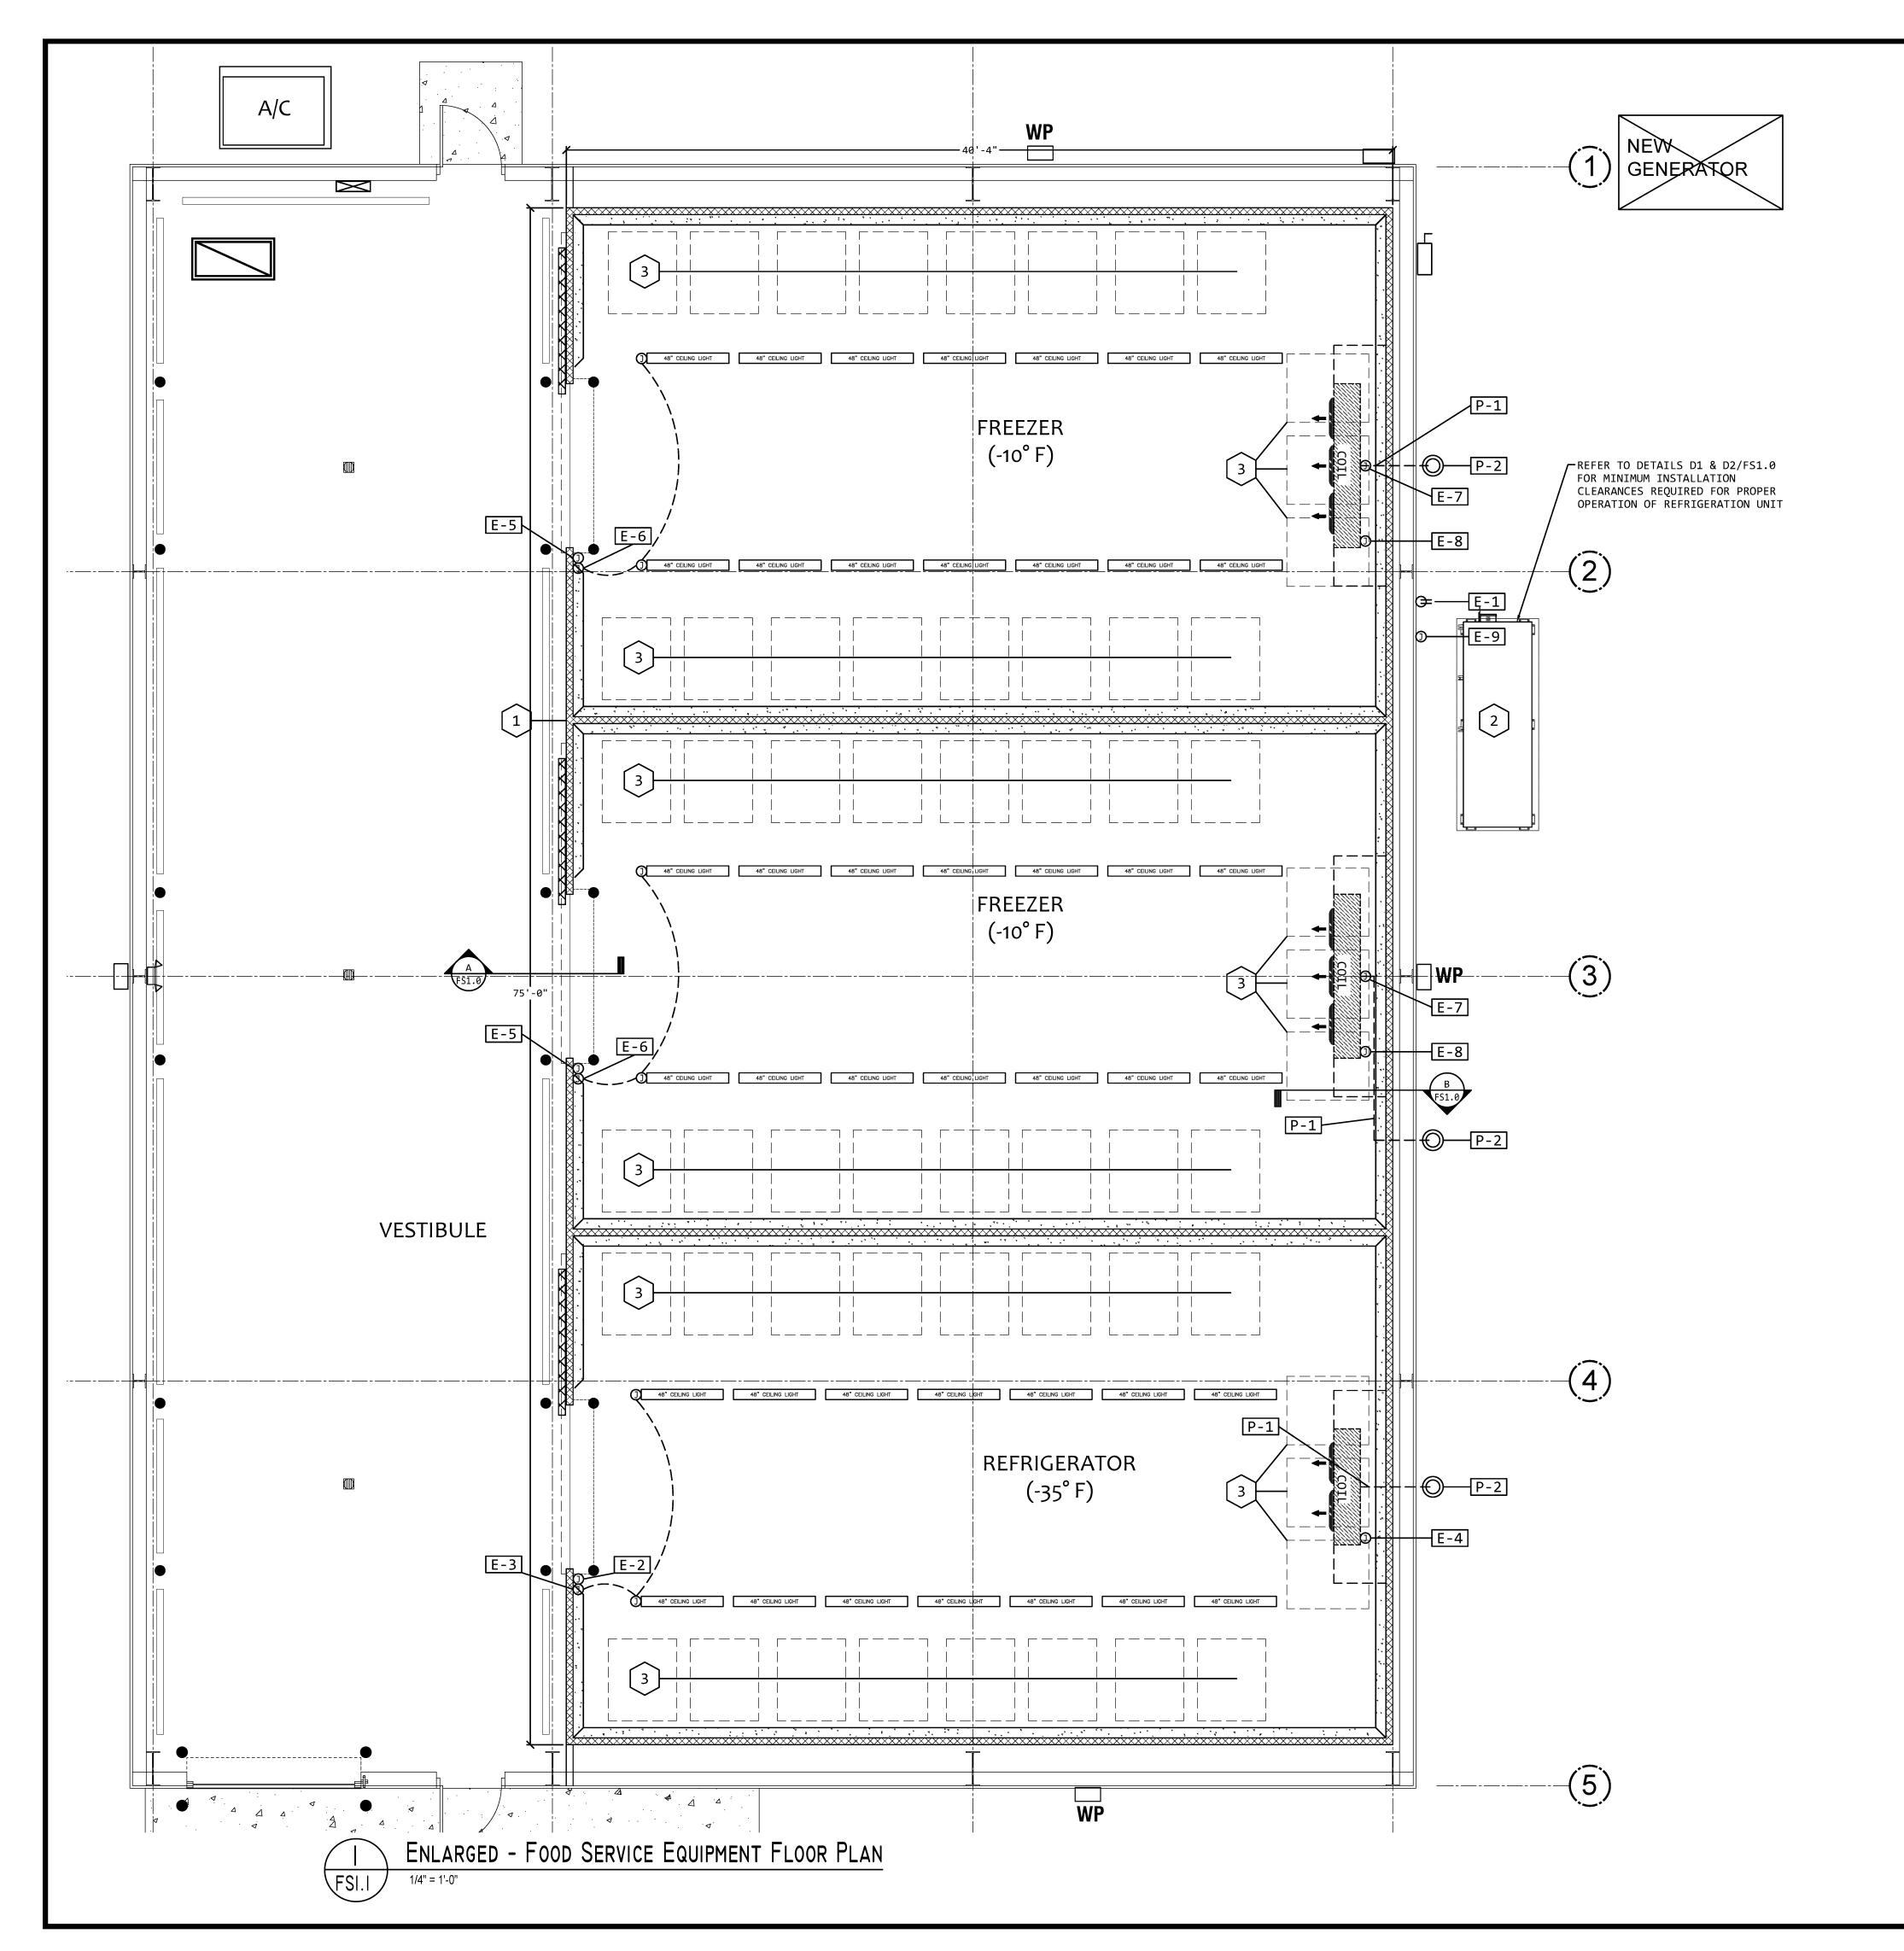
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EQUIPMENT CLASSIFICATION:

A. DIVISION 11 (FOOD SERVICE EQUIPMENT)

B. FOOD SERVICE EQUIPMENT - OWNER FURNISHED, OWNER INSTALLED

		ELECTRICAL ROUGH-IN DATA SCHEDULE	
CONN. NO.	ITEM NO.	DESCRIPTION OF UTILITY REQUIREMENTS	NOTES
E-1		120V CO, 24" AFF	
E-2	1	10A 120V DFA FOR DOOR FRAME HEATER, PRESSURE RELIEF PORT HEATER, AND	
		TEMPERATURE ALARM SYSTEM OF WALK-IN COOLER ROOM	6-9
E-3	1	6A 120V DFA FOR LED CEILING LIGHTS INSIDE WALK-IN COOLER ROOM	6-9
E-4	2	7A 120V 1-PH DFA FOR EVAPORATOR COIL OF WALK-IN COOLER ROOM	6,7,8,10
E-5	1	10A 120V DFA FOR DOOR FRAME HEATER, PRESSURE RELIEF PORT HEATER, AND	
		TEMPERATURE ALARM SYSTEM OF EACH WALK-IN FREEZER ROOM	6-9
E-6	1	6A 120V DFA FOR LED CEILING LIGHTS INSIDE EACH WALK-IN FREEZER ROOM	6-9
E-7	2	2A 120V DFA FOR EACH CONDENSATE DRAIN LINE HEATER OF EACH WALK-IN FREEZER ROOM	6-8
E-8	2	23.2A 208V 3-PH DFA FOR EVAPORATOR COIL OF EACH WALK-IN FREEZER ROOM	6,7,8,10
E-9	2	60A 480V 3-PH CIRCUIT (56.3 MCA) 36" ABOVE CONCRETE PAD FOR WALK-IN COOLER/FREEZER	_
		REMOTE CONDENSING UNIT	11

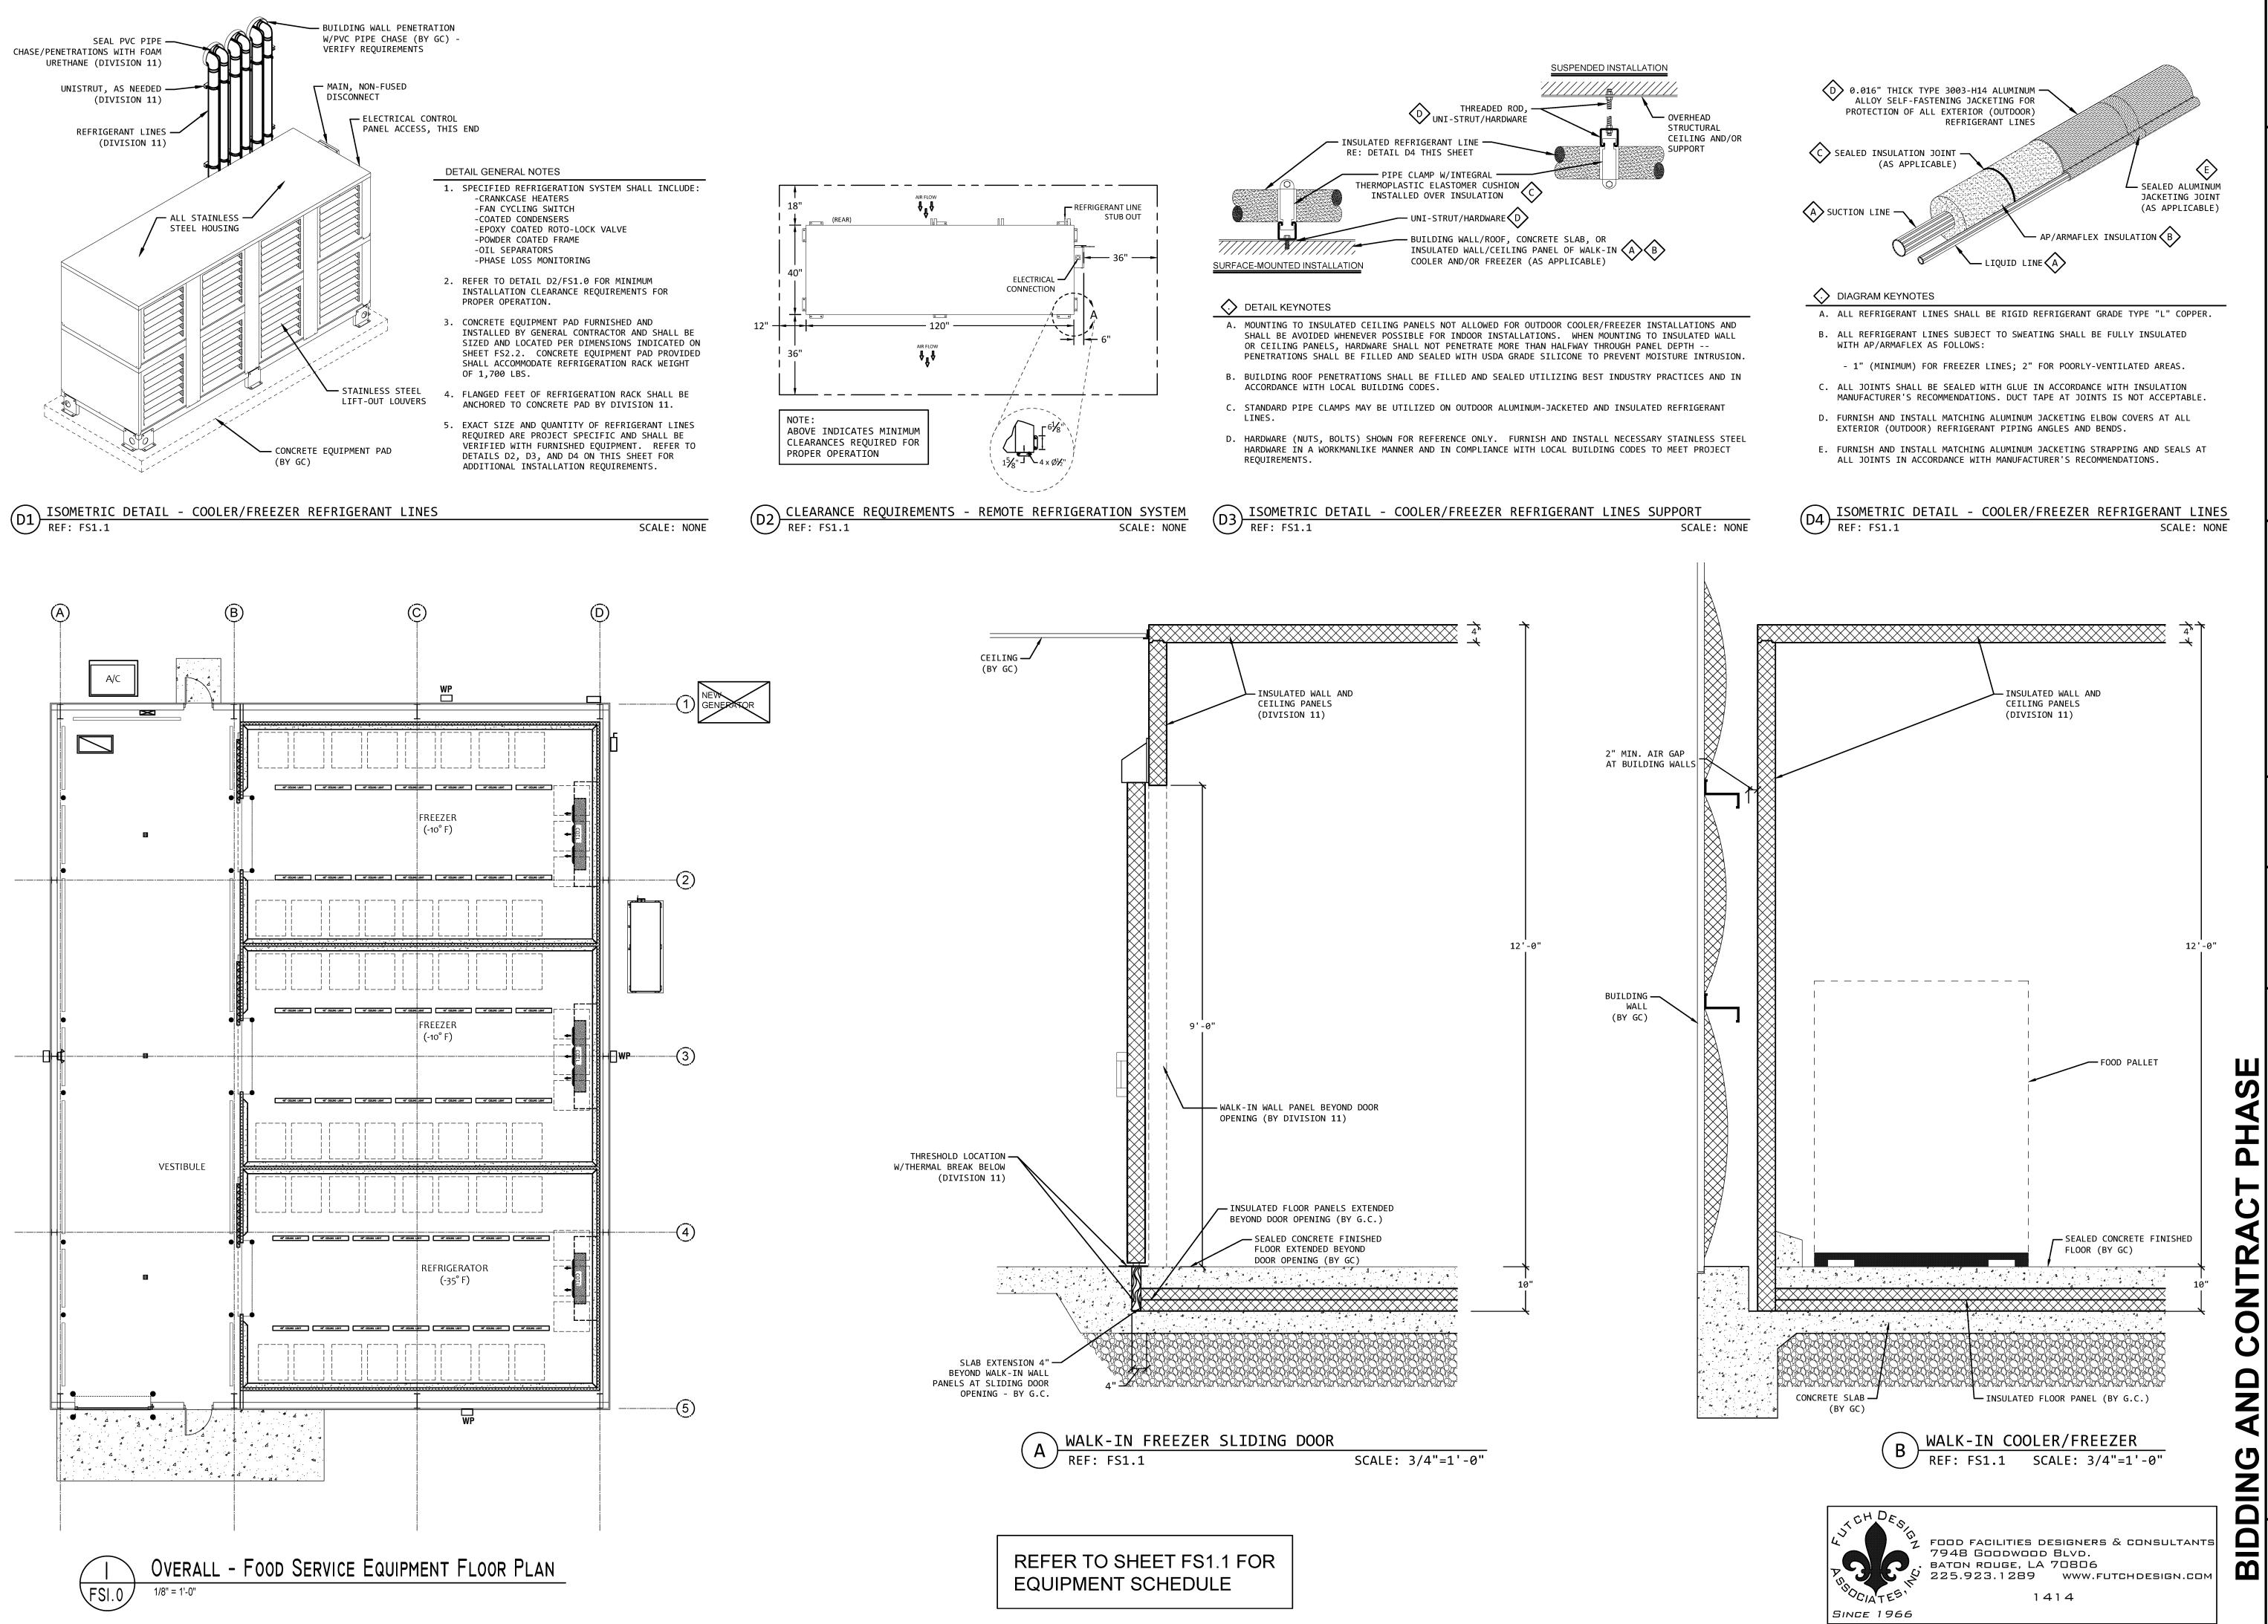ELECTRICAL ROUGH-IN DATA NOTES

- . ROUGH-IN PLAN SHOWS APPROXIMATE LOCATIONS FOR UTILITY REQUIREMENTS OF FOOD SERVICE EQUIPMENT SPECIFIED. CONTRACTOR SHALL FURNISH DIMENSIONED LOCATIONS FROM FINISHED WALLS AND/OR CENTER-LINE OF COLUMNS FOR ALL UTILITIES SHOWN ON CONTRACT DOCUMENT ROUGH-IN DRAWINGS.
- 2. WHERE POSSIBLE, ALL ELECTRICAL CONDUIT/WIRING SHALL BE EXTENDED UP THROUGH AND OUT OF BUILDING WALLS.
- 3. EXTEND AND CONNECT WIRING FROM JUNCTION BOXES TO CONNECTION POINTS ON FOOD SERVICE EQUIPMENT DIVISION 26..
- 4. WALL-MOUNTED JUNCTION BOXES SHALL BE RECESSED IN BUILDING WALL SO THAT EQUIPMENT CAN BE INSTALLED AGAINST WALLS.
- 5. FURNISH AND INSTALL ALL NECESSARY LINE DISCONNECT SWITCHES, UNLESS SPECIFIED OTHERWISE DIVISION 26.
- . FURNISH AND INSTALL CONDUIT, JUNCTION BOXES, AND FIELD WIRING FOR COILS, CEILING-MOUNTED LIGHT FIXTURES, PRESSURE RELIEF PORTS, AND FREEZER DRAIN LINE HEATERS OF WALK-IN COOLERS/AND FREEZERS DIVISION 26.
- 7. ELECTRICAL CONDUIT WITHIN WALK-IN SHALL BE FILLED (INSIDE CONDUIT) WITH FOAM URETHANE TO PREVENT CONDENSATION DIVISION 26.
- 8. PENETRATIONS OF WALK-IN CEILING/WALL PANELS SHALL BE SEALED WITH USDA-APPROVED SEALANT.
- 9. FURNISH AND INSTALL 18 GAUGE WIRING AND TEMPERATURE SENSORS OF TEMPERATURE ALARM SYSTEMS IN ACCORDANCE WITH SPECIFICATIONS DIVISION 11. REFER TO TEMPERATURE ALARM SYSTEM WIRING DIAGRAM D11, SHEET FS2.2.
- 10. WALK-IN FREEZER EVAPORATOR COIL SPECIFIED INCLUDES PRE-WIRED ON-DEMAND DEFROST CONTROLLER.
- 11. FURNISH AND INSTALL PRE-WIRED UL-LISTED CIRCUIT BREAKERS AND LINE DISCONNECT SWITCH DIVISION 26.

		PLUMBING ROUGH-IN DATA SCHEDULE	
CONN. NO.	ITEM NO.	DESCRIPTION OF UTILITY REQUIREMENTS	NOTES
P-1	1	3/4" TYPE "L" COPPER CONDENSATE DRAIN LINE FROM EVAPORATOR COILS WITHIN	
		WALK-IN COOLER AND FREEZER ROOMS TO DRY WELL LOCATED OUTSIDE OF BUILDING	2,3
P-2	1	DRY WELL (BY FSEC) FOR EVAPORATOR COIL DRAIN LINES OF WALK-IN COOLER/FREEZER	

PLUMBING ROUGH-IN DATA NOTES

- 1. ROUGH-IN PLAN SHOWS APPROXIMATE LOCATIONS FOR UTILITY REQUIREMENTS OF FOOD SERVICE EQUIPMENT SPECIFIED. CONTRACTOR SHALL FURNISH DIMENSIONED LOCATIONS FROM FINISHED WALLS AND/OR CENTER-LINE OF COLUMNS FOR ALL UTILITIES SHOWN ON CONTRACT DOCUMENT ROUGH-IN DRAWINGS.
- 2. SLOPE CONDENSATE DRAIN LINES GENEROUSLY (1/2" PER LINEAL FOOT MINIMUM) FROM WALK-IN COOLER AND FREEZER COILS TO 6" ABOVE WALK-IN FLOOR AND EXTEND THROUGH WALK-IN PANELS AND BUILDING WALLS (WHERE APPLICABLE) TO DRY WELL. DRAIN LINE TRAP AND 2" AIR-GAP REQUIRED. REFER TO DETAILS D9 AND D10, SHEET FS2.1.
- 3. WALK-IN PANEL PENETRATIONS FOR REFRIGERANT PIPING AND DRAIN LINES SHALL BE SEALED WITH FOAM URETHANE.



FOOD FACILITIES DESIGNERS & CONSULTANTS
7948 GOODWOOD BLVD.
BATON ROUGE, LA 70806
225.923.1289 www.futchdesign.com

3.1289 www.futchdesign.i

CRESS & LOPRESTO
ARCHITECTS L.L.C.

A PROFESSIONAL ARCHITECTURAL COMPANY
10606 COURSEY BLVD., STE. A
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REVISIONS

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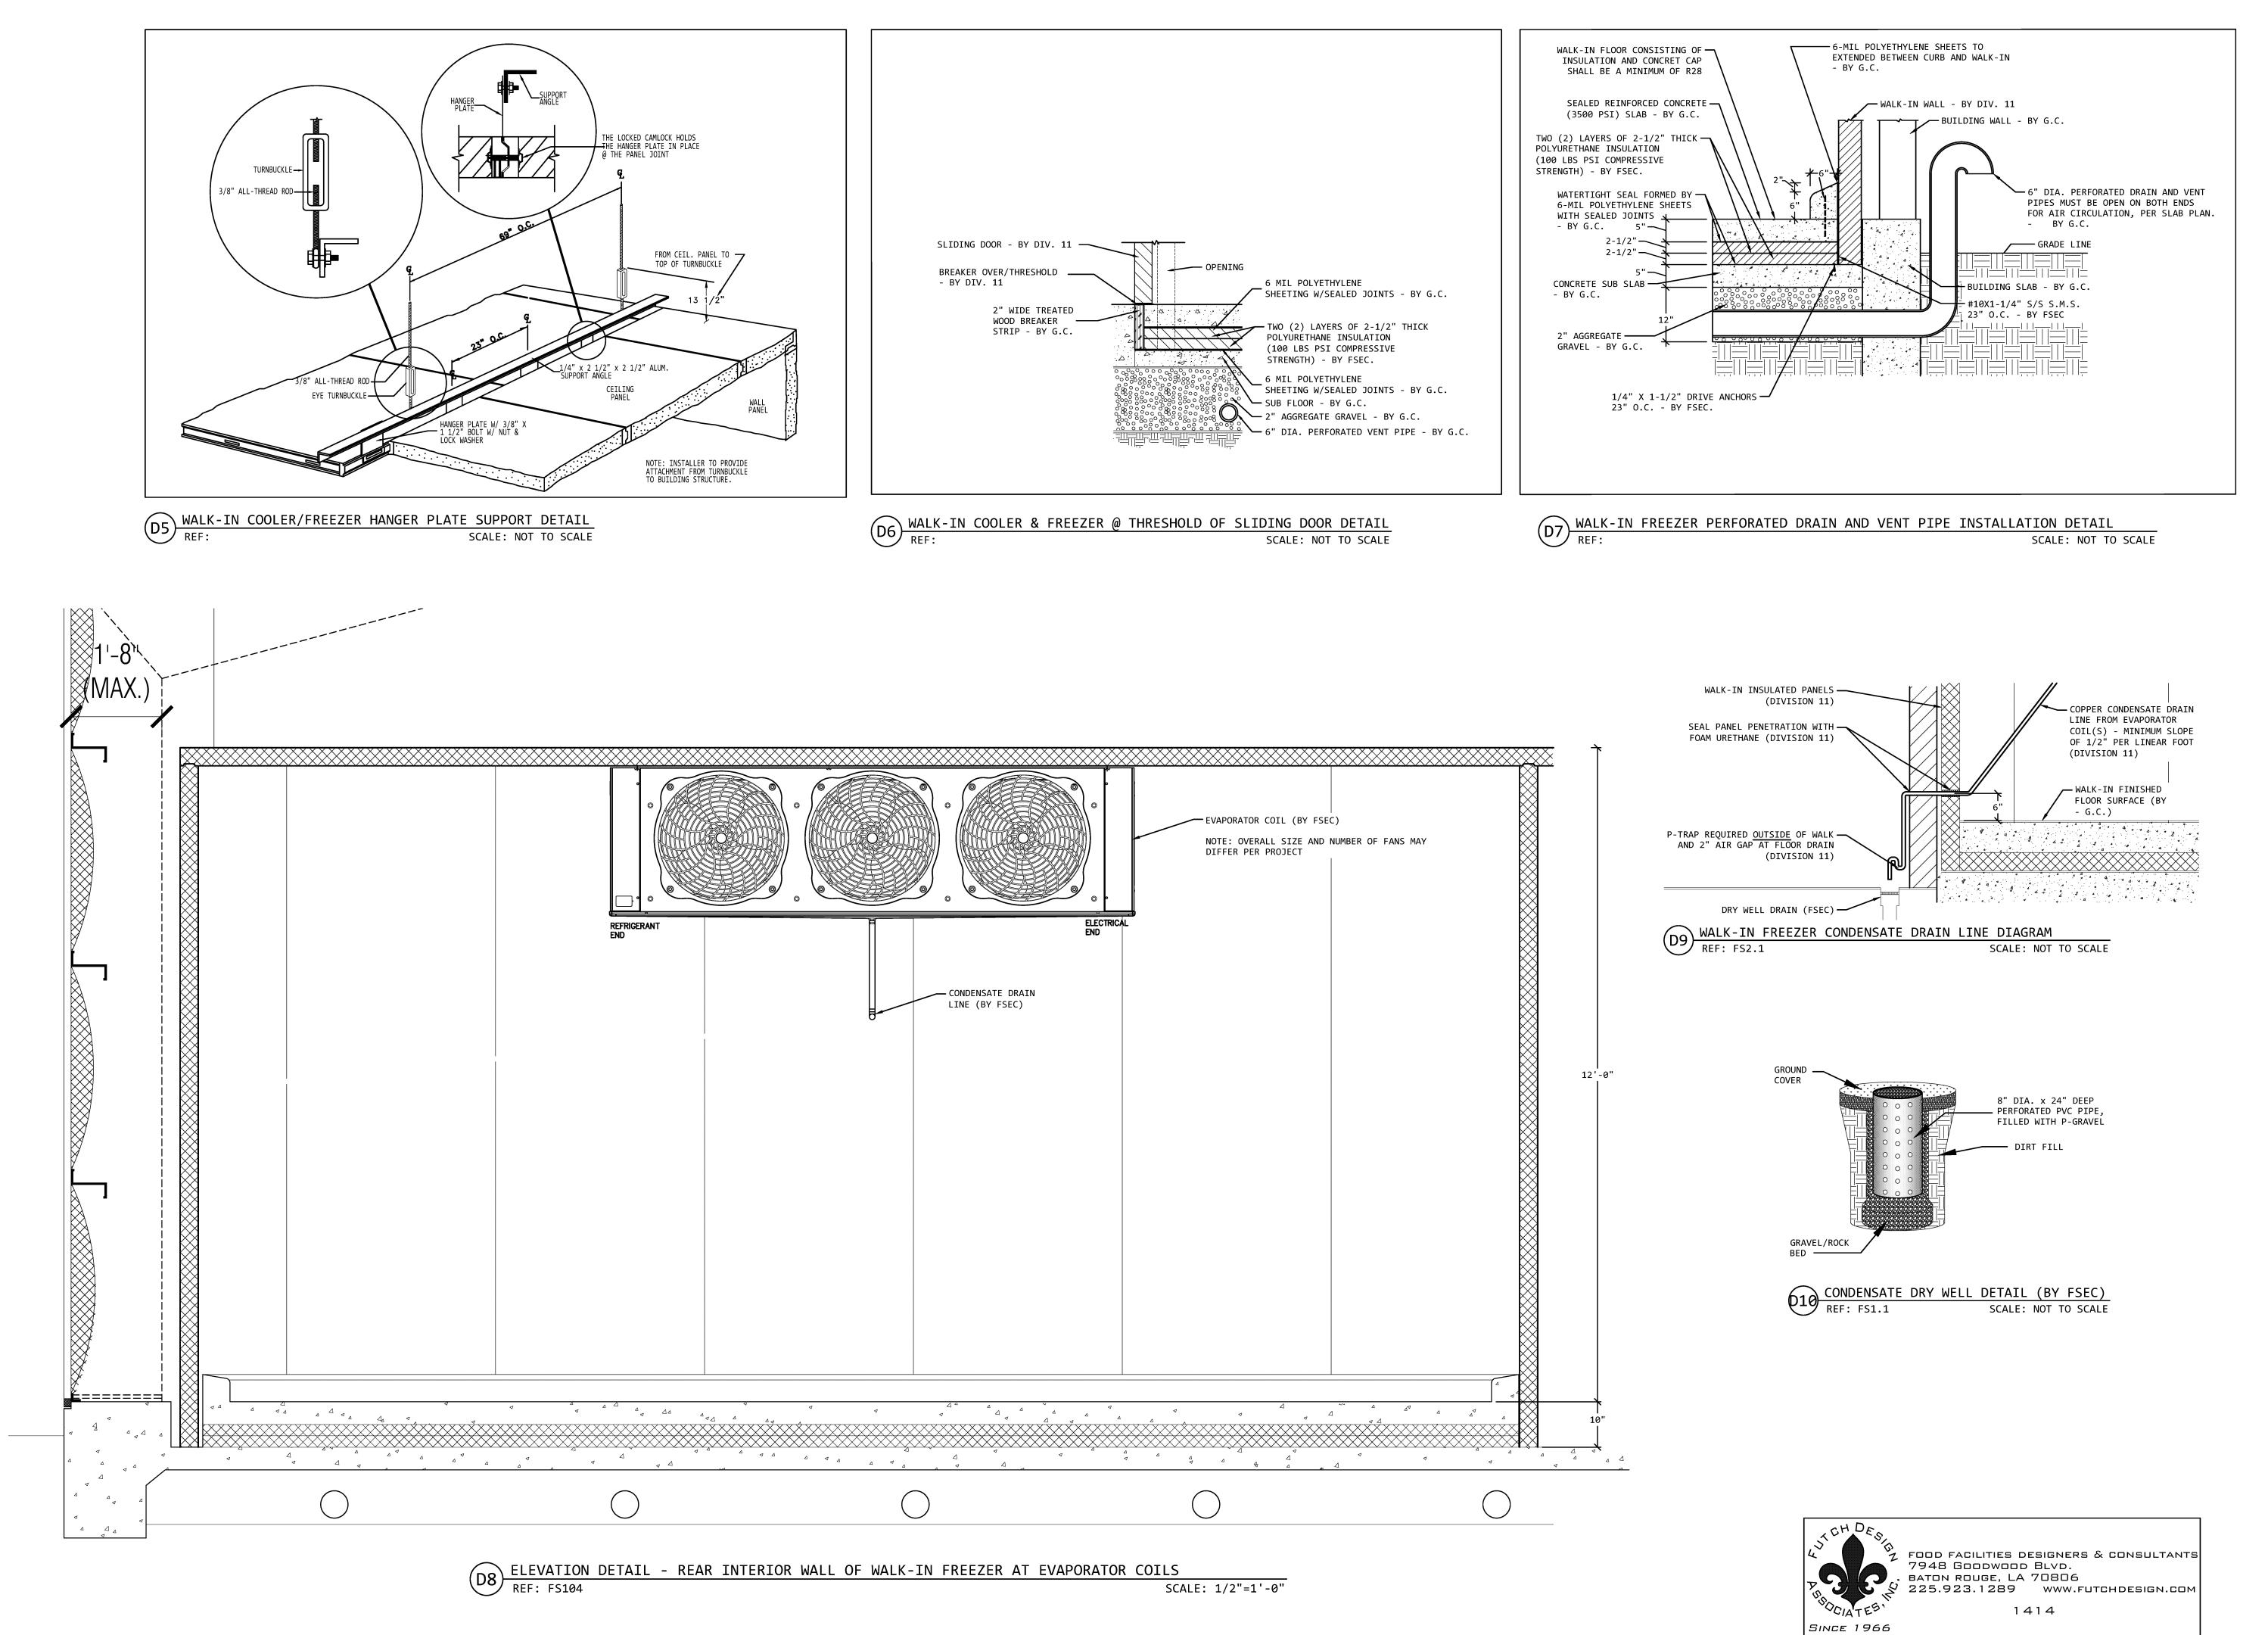
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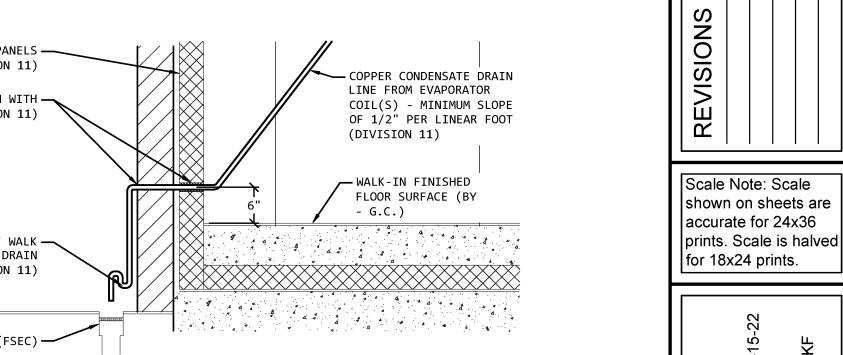
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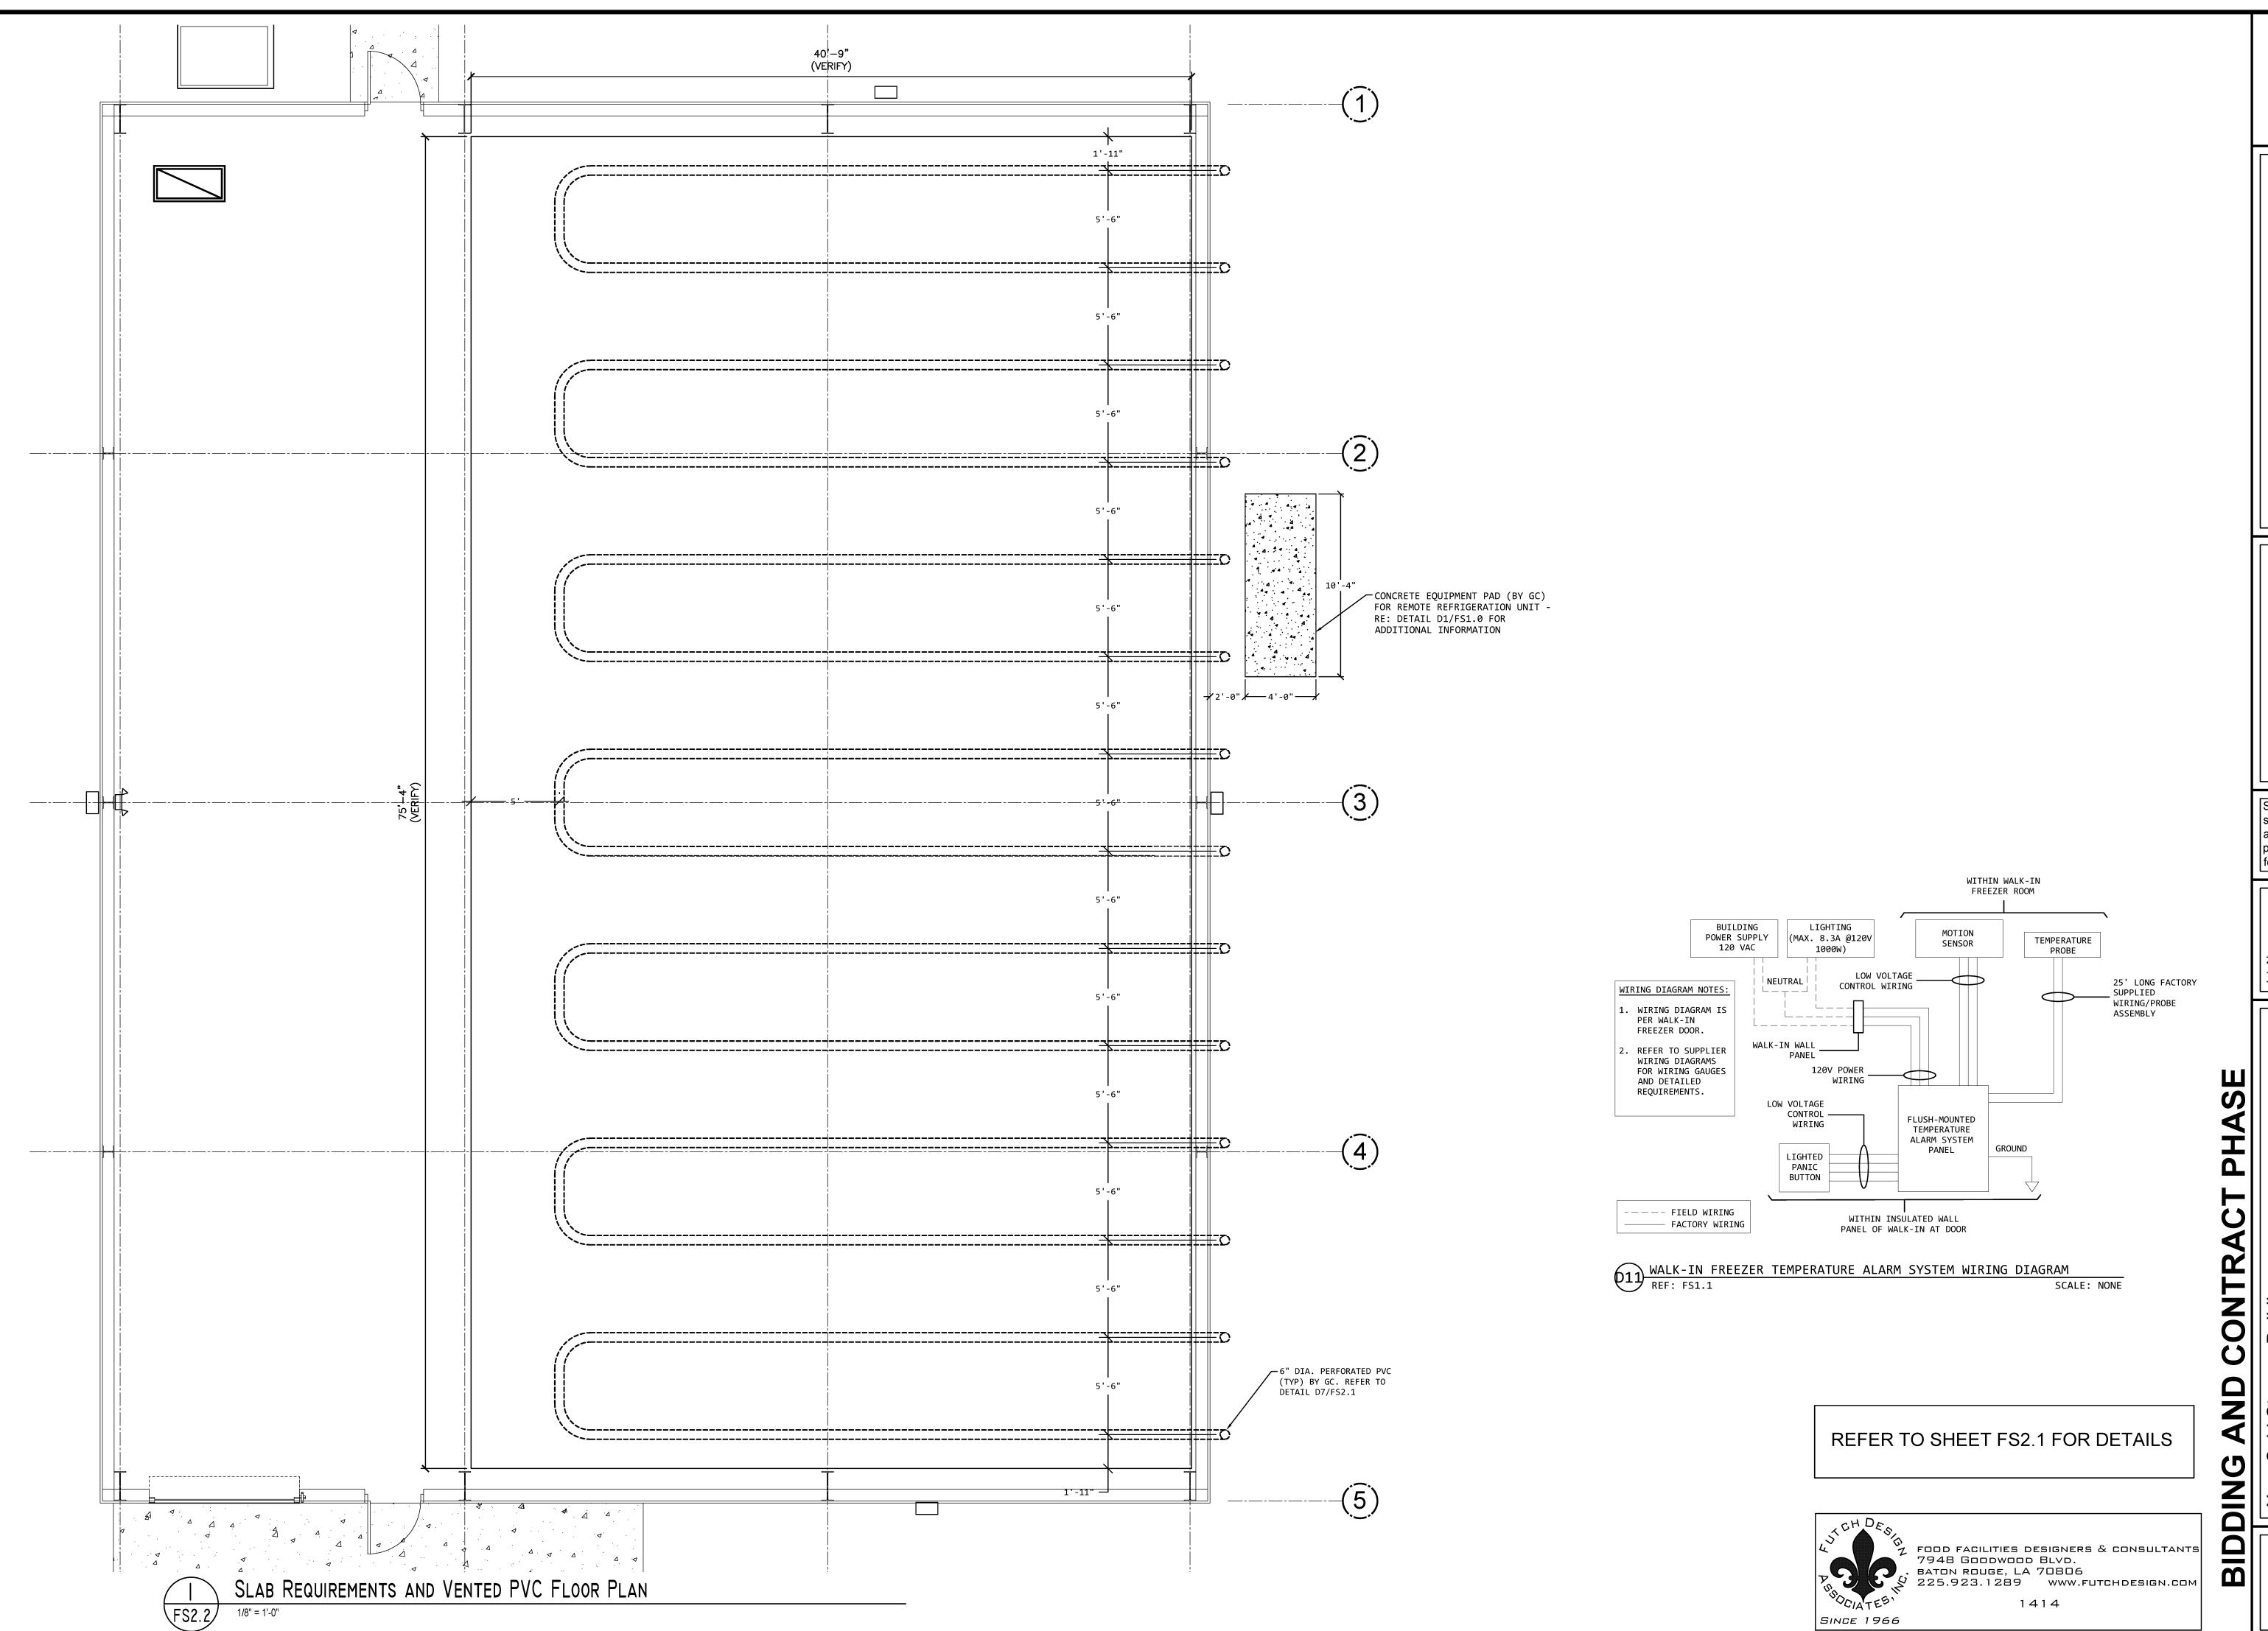
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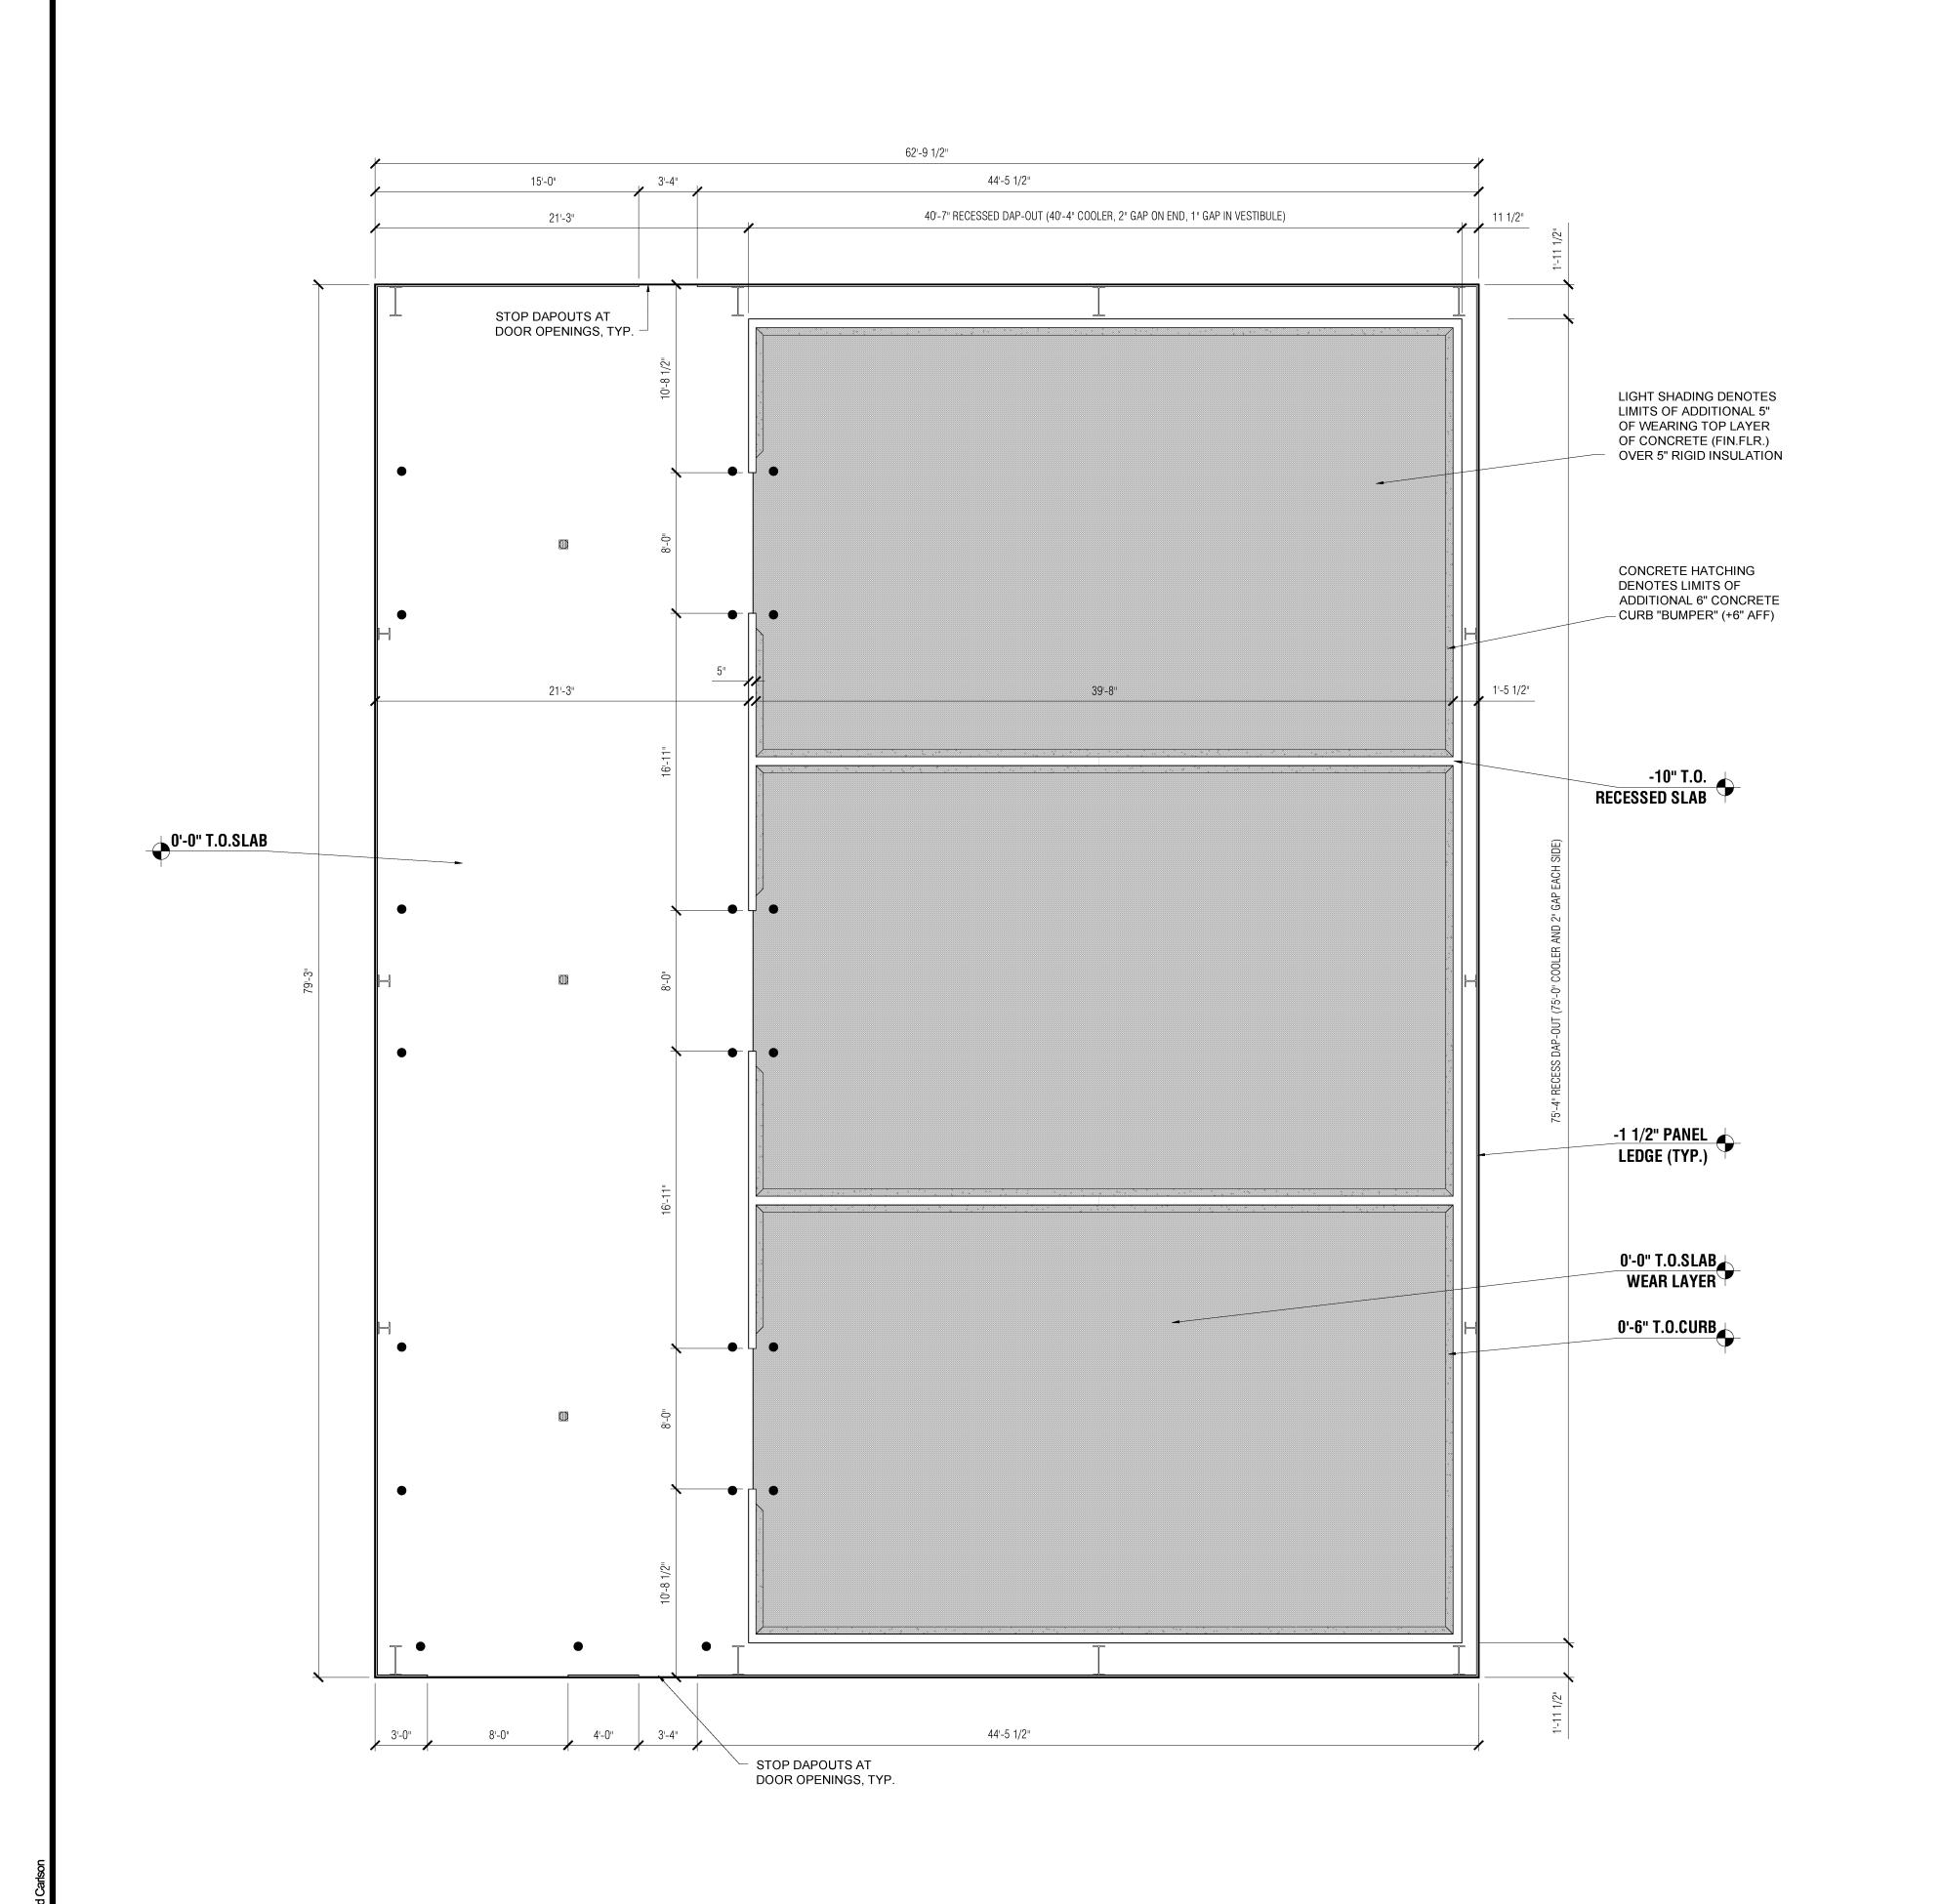
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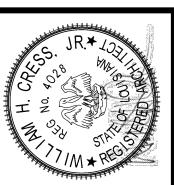






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REVISIONS

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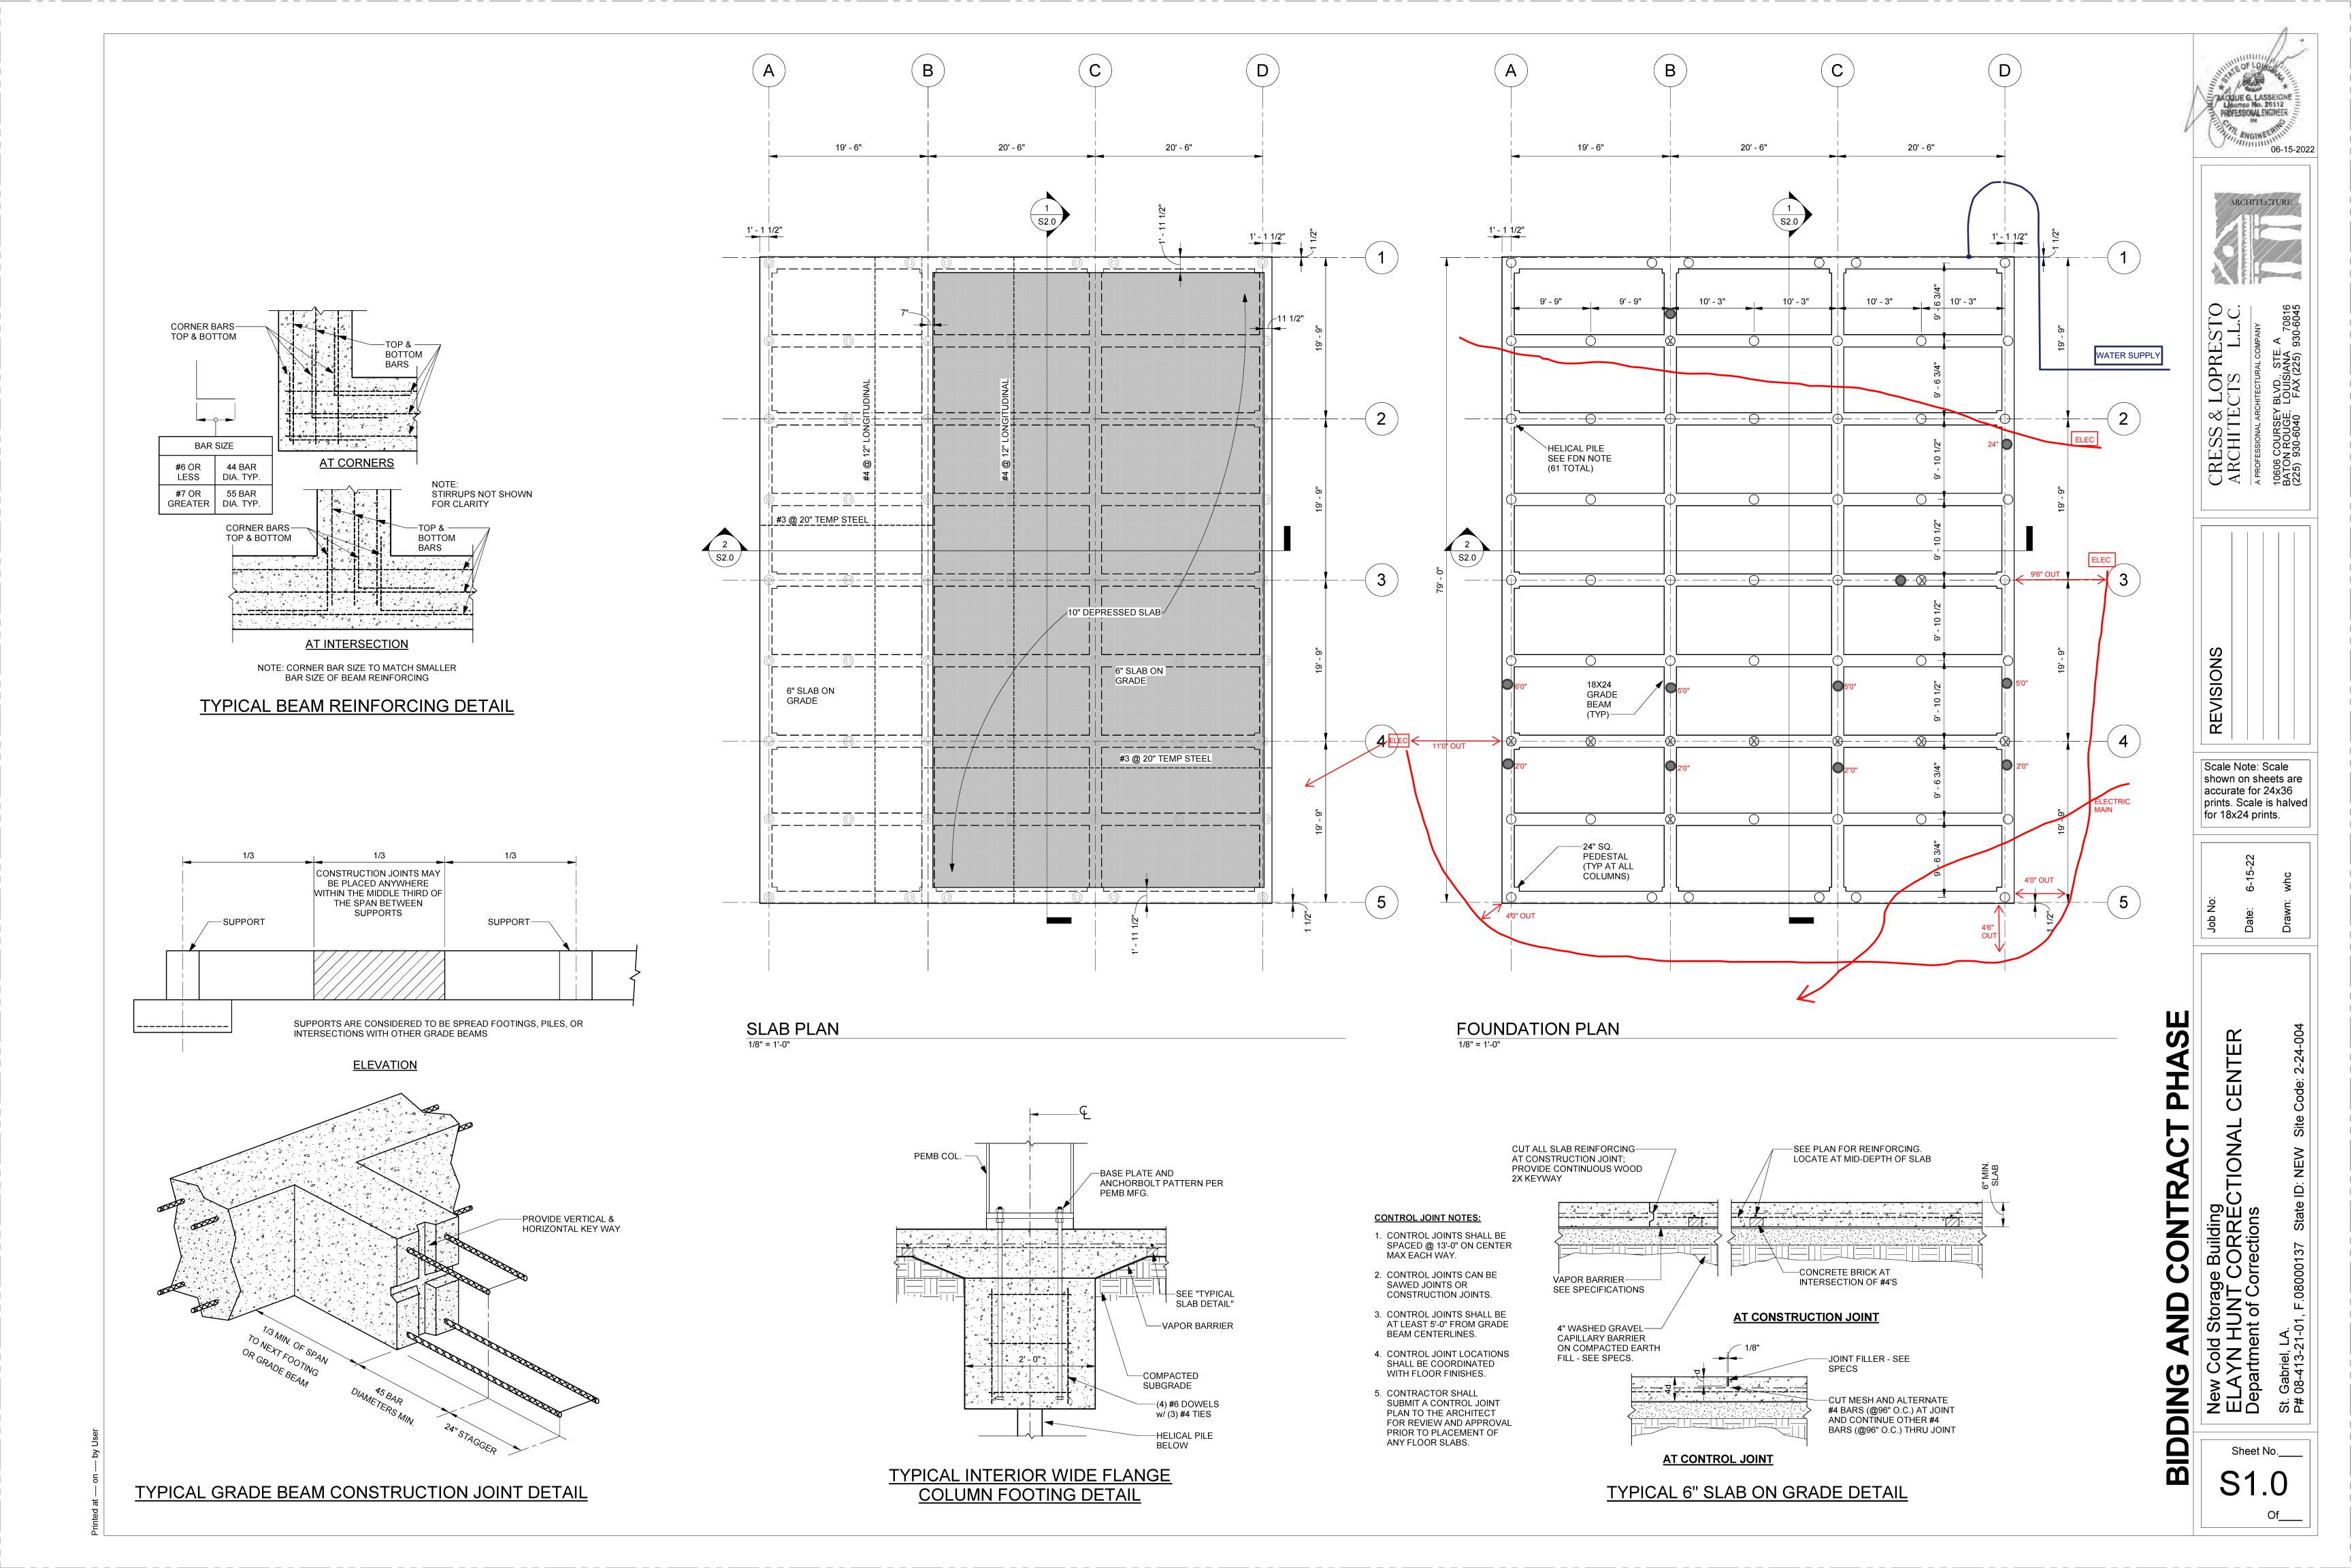
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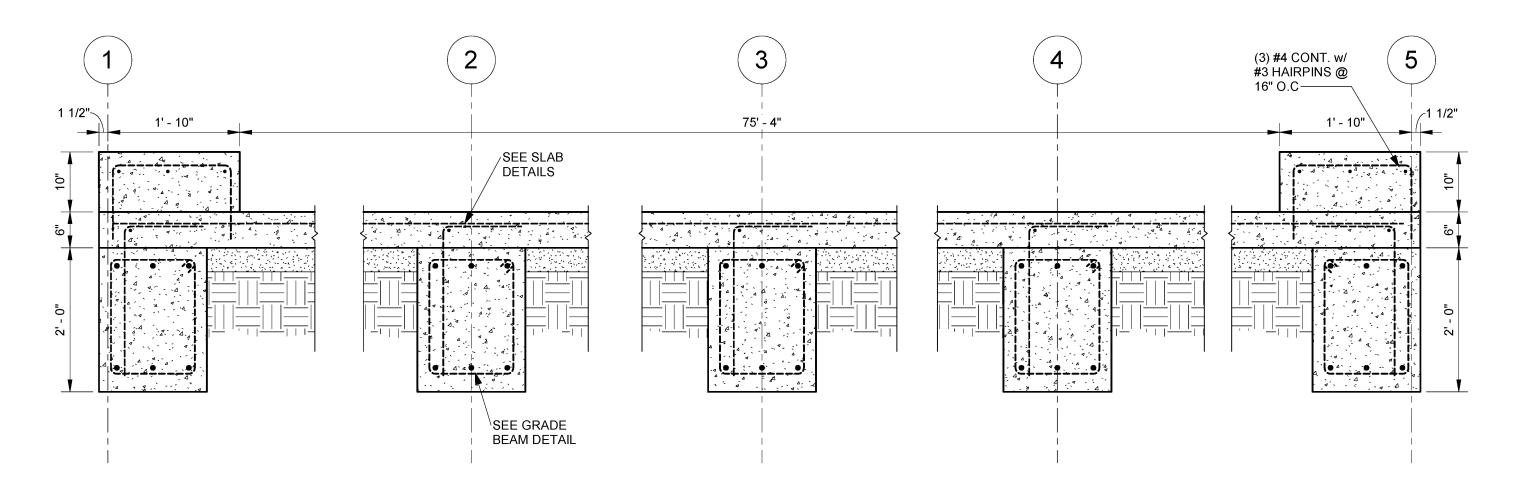
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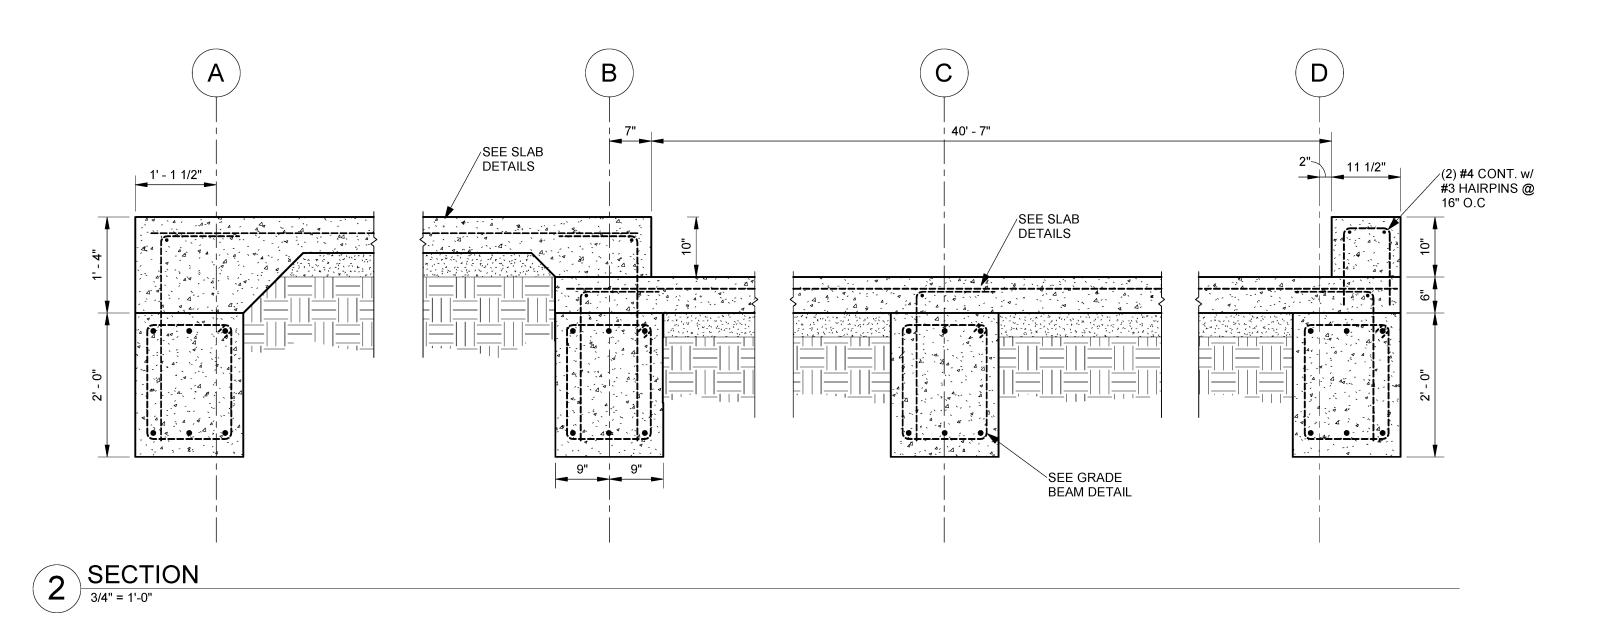
BIDDING

AND CONTRACT PHASE





SECTION 3/4" = 1'-0"




SOIL AND FOUNDATION NOTES:

- 1. THIS FOUNDATION DESIGN WAS BASED ON AND IS RELIANT UPON THE GEOTECHNICAL INVESTIGATION FOR THIS PROJECT AS PREPARED BY TOLUNAY-WONG ENGINEERS, GEISMAR, LA. PROJECT NUMBER 22.33.412 REPORT NO. 29669 DATED APRIL 22, 2022.
- 2. STRICT ADHERENCE TO THIS PLAN AND GEOTECHNICAL REPORT RECOMMENDATIONS IS REQUIRED. A COPY OF THEIR REPORT IS AVAILABLE AT THE ARCHITECT'S OFFICE FOR REVIEW.
- 3. UNLESS OTHERWISE NOTED IN THE GEOTECHNICAL REPORT, ALL FILL AND BACKFILL UNDER THE BUILDING AND FIVE FEET BEYOND THE BUILDING FOUNDATION SHALL BE SELECT MATERIAL COMPACTED TO WITHIN 95% OF THE STANDARD PROCTOR DENSITY AT OPTIMUM MOISTURE CONTENT.
- 4. UNLESS OTHERWISE NOTED IN THE GEOTECHNICAL REPORT, ALL FILL AND BACKFILL MATERIAL SHALL HAVE A "CL" CLASSIFICATION WITH A LIQUID LIMIT LESS THAN 45 AND A PLASTICITY INDEX BETWEEN 8 AND 25.
- EARTH FORMS ARE ACCEPTABLE PROVIDED THE SOIL IS FIRM ENOUGH TO MAINTAIN STABILITY OF THE EXCAVATIONS BEFORE AND DURING THE INSTALLATION OF CONCRETE.
- 6. AT TRANSFORMER PAD, PROVIDE 6" THICK CONCRETE PAD REINFORCED w/#4 BARS @ 12" SPACING IN BOTH DIRECTIONS. COORDINATE WITH TRANSFORMER MFG TO APPROPRAITELY SIZE PAD DIMENSIONS. PROVIDE A SINGLE HELICAL PILE LOCATED UNDER THE TRANSFORMER EQUIPMENT CENTER OF GRAVITY.
- 7. HELICAL PILE DATA:
 CAPACITY = 25 KIP ALLOWABLE LOAD (S.F. = 2)
 SHAFT = 4 1/2" DIA x 0.337" WALL THICKNESS
- SHAFT = 4 1/2" DIA x 0.337" WALL THICKNESS SHAFT YIELD STRENGTH = 50 ksi
- SHAFT DEPTH = 98 feet
- HELICES CONFIG = (4) 18" DIAMETER HELICES x 1/2" THICK @ 4'-6" SPACING MINIMUM INSTALLATION TORQUE = 9,000 ft-lbs.
- MINIMUM PILE SPACING = 4'-6"

CONCRETE AND REINFORCING STEEL NOTES:

- 1. ALL CONCRETE AND REINFORCING STEEL SHALL CONFORM TO THE LATEST ACI CODE.
- UNLESS SPECIFICALLY NOTED OTHERWISE ON THESE PLANS, ALL CONCRETE SHALL DEVELOP A MINIMUM 28 DAY COMPRESSIVE STRENGTH OF 3,000 PSI FOR SLABS AND 4,000 PSI FOR ALL CONCRETE BELOW SLABS/PAVING.
- UNLESS SPECIFICALLY NOTED OTHERWISE ON THESE PLANS, ALL REINFORCING STEEL SHALL CONFORM TO ASTM A615, GRADE 60.
- 4. WHERE REINFORCING STEEL IS CALLED TO BE WELDED, WELDABLE REINFORCING STEEL SHALL BE
- 5. PROVIDE ALL NECESSARY REINFORCING STEEL ACCESSORIES REQUIRED TO SECURELY HOLD THE REINFORCING STEEL IN THE POSITION SHOWN ON THESE PLANS.
- 6. ALL REINFORCING IN MEMBERS IN CONTACT WITH THE EARTH BUT NOT FORMED AGAINST EARTH SHALL HAVE A MINIMUM OF TWO (2) INCHES OF CONCRETE COVER.
- 7. ALL REINFORCING IN FACES OF MEMBERS FORMED AGAINST THE EARTH SHALL HAVE A MINIMUM OF THREE (3) INCHES OF CONCRETE COVER.
- 8. ALL REINFORCING BAR LAPS SHALL BE 44 BAR DIAMETERS FOR #6 OR SMALLER AND 55 BAR DIAMETERS FOR #7 OR LARGER. GRADE BEAM TOP BARS SHALL BE SPLICED WITHIN THE MIDDLE THIRD OF BEAM SPAN. GRADE BEAM BOTTOM BARS SHALL BE SPLICED AT BEAM SUPPORTS.



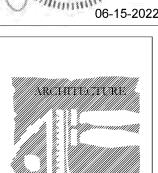

TS L.L.C.

ECTURAL COMPANY

VD., STE. A

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ARCHITECTS

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REVISIONS

Scale Note: Scale shown on sheets are accurate for 24x36 prints. Scale is halved for 18x24 prints.

Date: 6-15-22 Drawn: whc

CENTER

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OI COLLECLIOLIS F.08000137 State ID: NEW Site (

LAYN HUNT COR spartment of Correcti Gabriel, LA.


St. Gabriel, LA. P# 08-413-21-01,

Sheet No.___

PHASE

CONTRACT

BIDDING

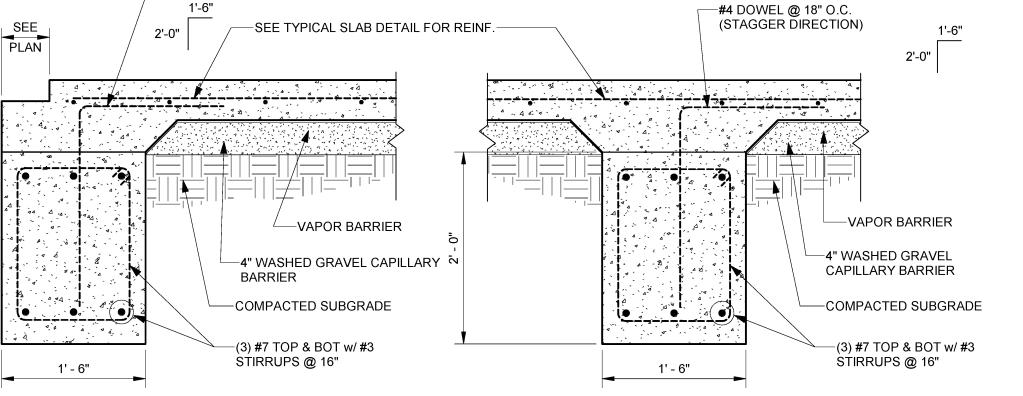

EXTERIOR GRADE BEAM DETAIL

−#4 DOWEL @ 18" O.C.

DETAIL INTERIOR GRADE BEAM DETAIL